Memorandum to the City of Markham Committee of Adjustment June 17, 2022

File: A/036/22

Address: 30 Stockport Road - Markham Applicant: Saira Khan and Sakheb Khan Agent: Building Experts Canada Hearing Date: Wednesday June 22, 2022

The following comments are provided on behalf of the East Team. The applicant is requesting relief from the following "Residential Two Exception *190 (R2*190) Zone" requirements under By-law 177-96, as amended:

a) Section 7.190.1

To permit a basement accessory dwelling unit, whereas the by-law requires an accessory dwelling unit to be above a private garage.

b) **Section 6.6.3(I)**

To permit an encroachment of 2.73 meters to the rear yard setback, whereas the by-law allows for 2 meter encroachment.

c) By-Law 28-97, Section 3.0, Table A:

To permit two parking spaces with an exterior parking width of 2.7 meters whereas the bylaw requires three spaces, and requires 2.75 meters for the exterior parking.

The above variances relate to a proposed secondary dwelling (basement apartment) within an existing semi-detached dwelling on the subject property.

BACKGROUND

Property Description

The 225 m² (2,422 ft²) subject property is located on the west side of Stockport Road, which is east of Bur Oak Avenue, south of Murray Wilson Drive and north of Almira Avenue, in the Cornell Community. The property is developed with a two-storey semi-detached dwelling and one-storey, one-car garage accessed by a rear lane. The garage is detached from the dwelling, but attached to a one-car garage for the abutting property to the north, 32 Stockport Road. A parking pad on the subject property is located on the south side of the garage. A total of two parking spaces are provided for the semi-detached dwelling (one in the garage and one on the parking pad). The southwest portion of the property is irregular in shape to accommodate a hydro transformer notch which is within the public lane right of way.

The property is located in an established residential neighbourhood comprised of a mix of two-storey detached, semi-detached and townhouse dwellings. A defining characteristic of the area are rear lanes to access parking and garages for low rise residential development. Also within proximity of the subject lands is the 4-storey Yee Hong Retirement Residence and 3-storey Bill Hogarth Public High School to the west and southwest on Bur Oak Avenue.

Proposal

The applicant is proposing to construct a basement apartment within the existing semidetached dwelling. Proposed access to the basement apartment is from exterior stairs located in the rear yard. The proposed development is shown in Appendix B.

The R2*190 zone permits an accessory dwelling, as a coach house unit above a detached private garage only. Stairs accessing a dwelling unit are permitted to encroach a maximum of 2.0 m (6.6 ft) into a required rear yard, which for the subject property is a required rear yard setback of 13.0 m (42.6 ft). Parking Standards By-law 28-97, as amended, requires two parking spaces for semi-detached dwellings, plus an additional parking space for an accessory dwelling unit (three total). The Parking By-law also requires parking spaces be 5.8 m (19.0 ft) long and 2.75 (9.0 ft) wide. Parking spaces within a garage are permitted to be 2.6 m (8.53 ft) wide.

The applicant is requesting variances to permit an accessory unit in basement of the existing semi-detached dwelling instead of a coach house above a detached garage; to permit stairs to encroach an additional 0.73 m (2.4 ft) into the required rear yard; to not require an third parking space for the accessory unit whilst recognizing that the existing parking pad is 2.70 m (8.86 ft) wide.

COMMENTS

Secondary Unit

Staff are satisfied that the proposed development meets the criteria under <u>Section 8.13.8</u> of the Official Plan for the establishment of a secondary suite, and support its approval in accordance with the requirements under Section 16(3) of the *Planning Act, R.S.O. 1990, c. P.13, as amended.*

Stair Encroachment

Staff are of the opinion that the proposed stair encroachment into the required 13.0 m (42.6 ft) rear yard setback will not impact the function and usability of rear yard amenity space or impact abutting properties. Staff are of the opinion that this requested variance is appropriate, maintains the intent of the Zoning By-law and Official Plan.

Parking Variances

As noted, staff are in support of the proposed secondary suite unit within the basement. In assessing the secondary suite, staff have evaluated the proposed reduction of one parking space for the unit and consider that to be appropriate. The proposed parking pad width reduction is a minimal reduction of 0.05 m (0.16 ft) from the requirement of 2.75 m (9.0) ft. This will not impact the usability of the parking pad, and staff therefore have no concerns with this requested variance.

Zoning Preliminary Review (ZPR) Undertaken

The owner has completed a Zoning Preliminary Review (ZPR) on February 18, 2022 to confirm the variances required for the proposed development.

PUBLIC INPUT SUMMARY

No written submissions were received as of June 1, 2022. It is noted that additional information may be received after the writing of the report, and the Secretary-Treasurer will provide information on this at the meeting.

CONCLUSION

Planning staff have reviewed the application with respect to Section 45(1) of the *Planning Act*, and are of the opinion that the requested variances meet the four tests. Staff recommend that the Committee consider public input and the subsequent conditions of approval in reaching a decision. The onus is ultimately on the applicant to demonstrate how they satisfy the tests of the *Planning Act* required for the granting of minor variances.

The onus is ultimately on the applicant to demonstrate why they should be granted relief from the requirements of the zoning by-law, and how they satisfy the tests of the Planning Act required for the granting of minor variances.

APPENDICES

Appendix "A" – Conditions of Approval

Appendix "B" – Plans

PREPARED BY:

Stephen Corr, Senior Planner II, East District

REVIEWED BY:

Stacia Muradali, Development Manager, East District


File Path: Amanda\File\ 22 113404 \Documents\District Team Comments Memo

APPENDIX "A" CONDITIONS TO BE ATTACHED TO ANY APPROVAL OF FILE A/024/22

- 1. The variance apply only to the proposed development for as long as it remains.
- 2. That the variances apply only to the proposed development, in substantial conformity with the plans attached as Appendix "B" to this Staff Report, and that the Secretary-Treasurer receive written confirmation from the Director of Planning and Urban Design or designate that this condition has been fulfilled to his or her satisfaction.
- 3. That the owner submit, if required by the Chief Building Official, a third-party report prepared by an architect or professional engineer licensed in the Province of Ontario, to assess compliance of existing construction with the provisions of the Ontario Building Code, and in particular relating to the change of use from a dwelling containing a single suite to a dwelling containing more than one suite.

CONDITIONS PREPARED BY:

Stephen Corr, Senior Planner II, East District

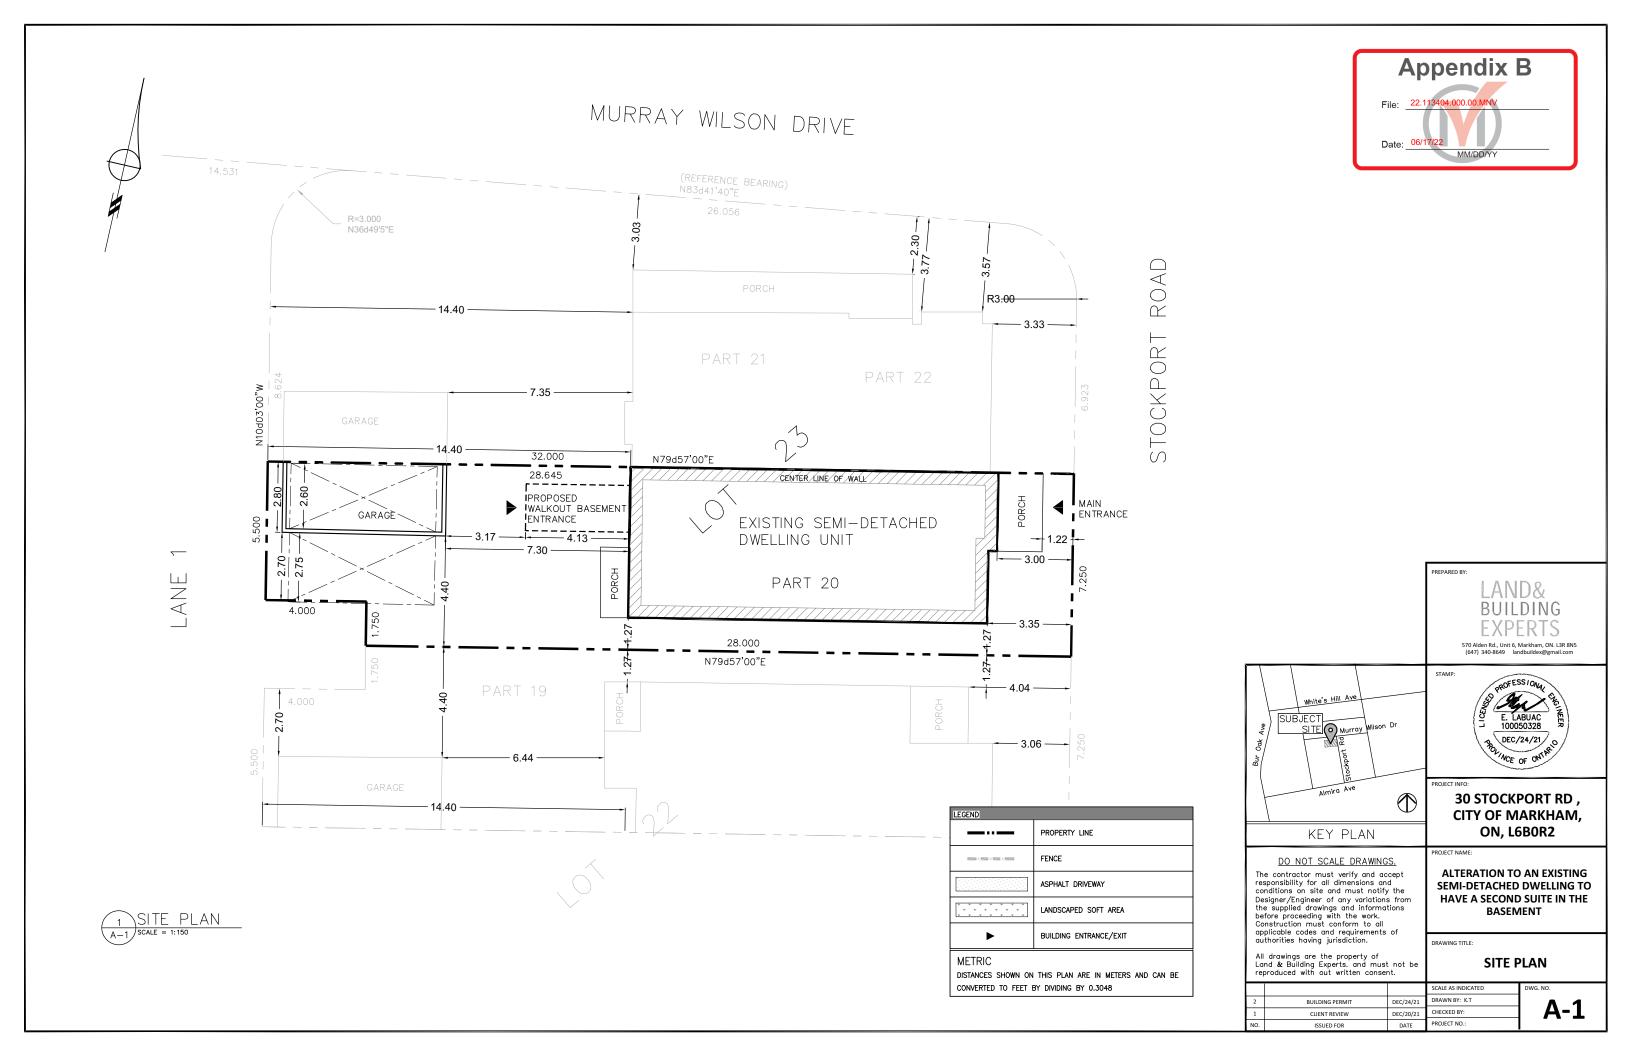


LEGEND	
EXISTING	
● EX	EXHAUST FAN
S .A	SMOKE ALARM
⊕ C.M.	CARBON MONOXIDE DETECTOR
REF	REFRIGERATOR
FUR	FURNACE
Н	HOT WATER TANK
S.G.	SUPPLY AIR GRILLES TO BE LOCATED ON THE CEILING
R.G	RETURN AIR GRILLES TO BE LOCATED ON THE CEILING

	WALL SCHEDULE
ML-1E	EXISTING 8"(203mm) POURED CONCRETE (WITH 12CI INSULATION), 2"X4"(50.8mmX101.6mm) WOOD STUDS @ 16"(406mm) O.C WITH INSULATION

BASEMENT HEIGHT = 2.33m (7'-8")HEIGHT UNDER DUCTS & BEAMS = 2.10 m (6'-11'')



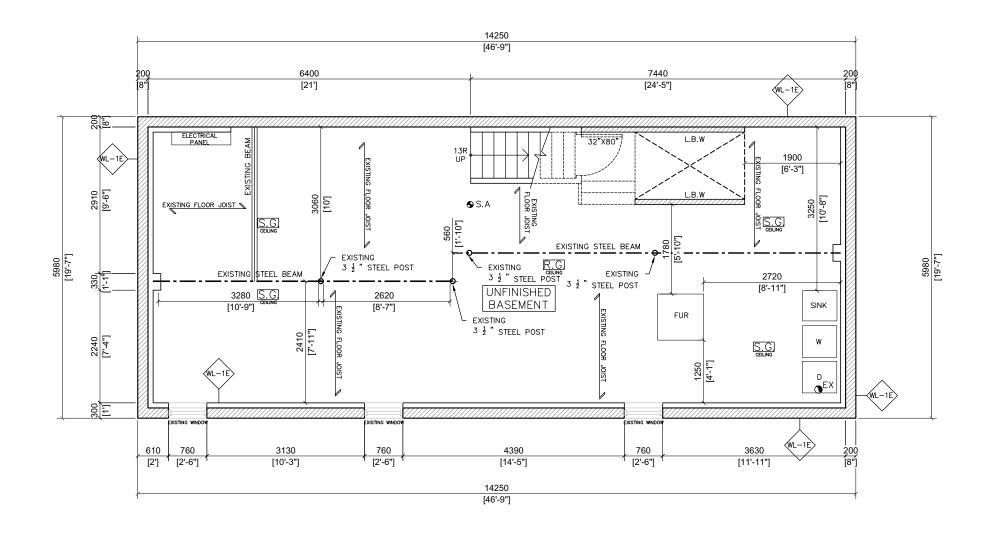



PREPARED BY: LAND& BUILDING 570 Alden Rd., Unit 6, Markham, ON. L3R 8N5 (647) 340-8649 landbuildex@gmail.com

E. LABUAC 100050328 DEC/24/21

PROJECT INFO:

30 STOCKPORT RD, CITY OF MARKHAM, **ON, L6B0R2**

DO NOT SCALE DRAWINGS.

The contractor must verify and accept responsibility for all dimensions and conditions on site and must notify the Designer/Engineer of any variations from the supplied drawings and informations before proceeding with the work.
Construction must conform to all applicable codes and requirements of authorities having jurisdiction.

All drawings are the property of Land & Building Experts. and must not be reproduced with out written consent.

ALTERATION TO AN EXISTING SEMI-DETACHED DWELLING TO HAVE A SECOND SUITE IN THE


BASEMENT


EXISTING BASEMENT PLAN

		SCALE AS INDICATED
BUILDING PERMIT	DEC/24/21	DRAWN BY: K.T
CLIENT REVIEW	DEC/20/21	CHECKED BY:
		PROJECT NO :

A-2

LEGEND	
EXISTING	
● EX	EXHAUST FAN
⊕ S.A	SMOKE ALARM
⊕ C.M.	CARBON MONOXIDE DETECTOR
REF	REFRIGERATOR
FUR	FURNACE
Н	HOT WATER TANK
S.G.	SUPPLY AIR GRILLES
R.G.	RETURN AIR GRILLES

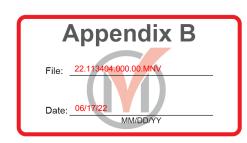

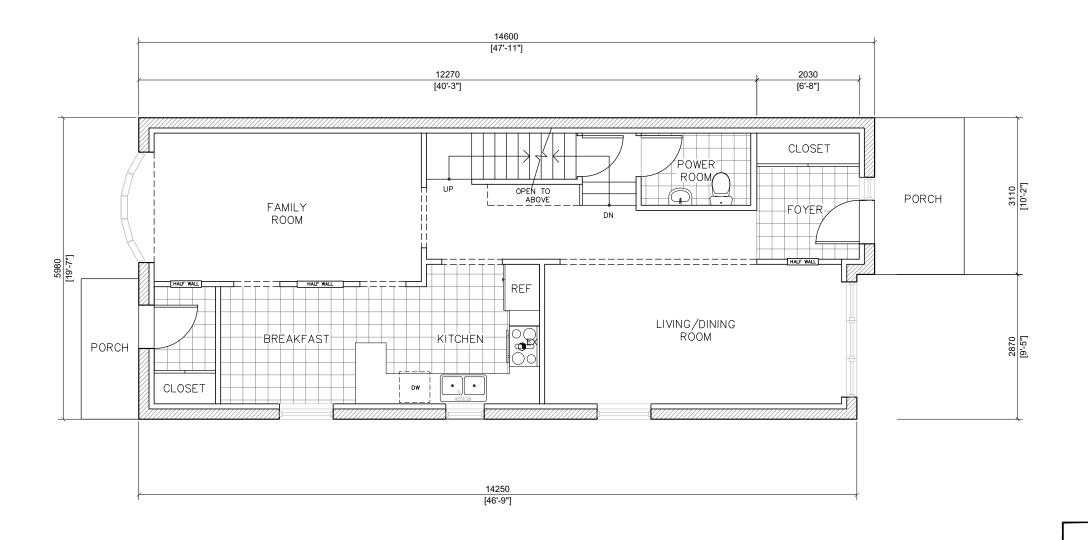





PROJECT INFO:

30 STOCKPORT RD, CITY OF MARKHAM, ON, L6B0R2

DO NOT SCALE DRAWINGS.

The contractor must verify and accept responsibility for all dimensions and conditions on site and must notify the Designer/Engineer of any variations from the supplied drawings and informations before proceeding with the work. Construction must conform to all applicable codes and requirements of authorities having jurisdiction.

All drawings are the property of Land & Building Experts. and must not be reproduced with out written consent.

ALTERATION TO AN EXISTING SEMI-DETACHED DWELLING TO

HAVE A SECOND SUITE IN THE **BASEMENT**


EXISTING FIRST FLOOR PLAN


		SCALE AS
BUILDING PERMIT	DEC/24/21	DRAWN
CLIENT REVIEW	DEC/20/21	CHECKED
ISSUED FOR	DATE	PROJECT

	SCALE AS INDICATED	DWG. NO.
1	DRAWN BY: K.T	A 3
1	CHECKED BY:	A-3
	PROJECT NO :	•



LEGEND	
EXISTING	
● EX	EXHAUST FAN
⊕ S.A	SMOKE ALARM
⊕ C.M.	CARBON MONOXIDE DETECTOR
REF	REFRIGERATOR
FUR	FURNACE
Н	HOT WATER TANK
S.G.	SUPPLY AIR GRILLES
R.G.	RETURN AIR GRILLES

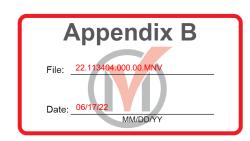

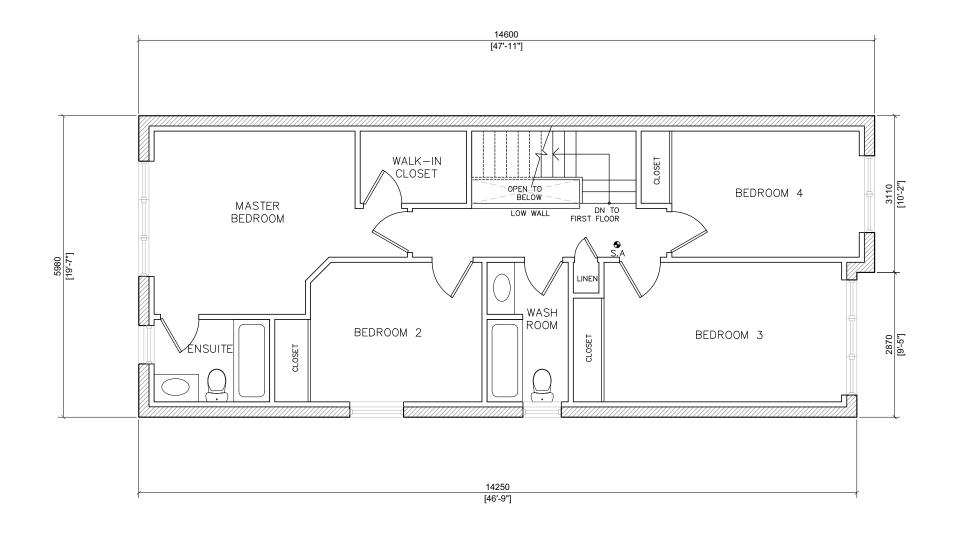

1 EXISTING SECOND FLOOR PLAN
A-4 SCALE = 1:75

PREPARED BY: LAND& BUILDING 570 Alden Rd., Unit 6, Markham, ON. L3R 8N5 (647) 340-8649 landbuildex@gmail.com

E. LABUAC 100050328 DEC/24/21

PROJECT INFO:

30 STOCKPORT RD, CITY OF MARKHAM, ON, L6B0R2

DO NOT SCALE DRAWINGS.

The contractor must verify and accept responsibility for all dimensions and conditions on site and must notify the Designer/Engineer of any variations from the supplied drawings and informations before proceeding with the work. Construction must conform to all applicable codes and requirements of authorities having jurisdiction.


All drawings are the property of Land & Building Experts. and must not be reproduced with out written consent.

ALTERATION TO AN EXISTING SEMI-DETACHED DWELLING TO HAVE A SECOND SUITE IN THE **BASEMENT**

DRAWING TITLE: EXISTING **SECOND FLOOR PLAN**

		SCALE AS INDI
BUILDING PERMIT	DEC/24/21	DRAWN BY: K.
CLIENT REVIEW	DEC/20/21	CHECKED BY:
ISSUED FOR	DATE	PROJECT NO.:

A-4

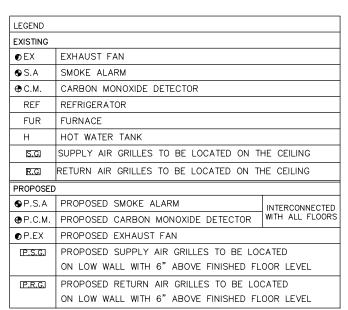

WALL SCHEDULE

EXISTING 8"(203mm) POURED CONCRETE (WITH 12CI INSULATION),
2"X4"(50.8mmX101.6mm) WOOD STUDS @ 16"(406mm) 0.C
WITH PROPOSED ½"(12.7mm) GYPSUM WALL BOARD, TAPED AND SANDED

PROPOSED 2"X4"(50.8mmX101.6mm) WOOD STUD WALL WITH $\frac{1}{2}$ "(12.7mm) GYPSUM WALL BOARD BOTH SIDES, TAPED AND SANDED

PROPOSED 2"X4"(50.8mmX101.6mm) WOOD STUD WALL WITH 5/8"(15.9mm) TYPE "X" (30 MINS. FRR)TO ENTIRE FURNACE ROOM WALL TAPED AND PAINTED

BASEMENT HEIGHT = 2.33 m (7'-8")

HEIGHT UNDER

DUCTS & BEAMS = 2.10m (6'-11")

NOTE: All THE EXISTING AND PROPOSED SMOKE ALARMS AND CARBON MONOXIDE DETECTORS WILL BE INTERCONNECTED THROUGHOUT THE ENTIRE FLOORS


NOTES FOR COMPLIANCE ALTERNATIVE: SINCE THE DWELLING HAS BEEN IN EXISTENCE FOR MORE THAN 5 YEARS THE FOLLOWING OBC PART 11 COMPLIANCE ALTERNATIVES ARE PROPOSED.

PART 11 COMPLAINCE ALTERNATIVES FOR RESIDENTIAL OCCUPANCIES (FORMING PART OF ARTICLE 11.5.1.1), TABLE 11.5.1.1C - C152(b), C153(b)

GENERAL NOTES:

- I. A SMOKE DETECTOR SHALL BE INSTALLED IN THE AIR DUCT SYSTEM WHICH WOULD TURN OFF THE FUEL SUPPLY AND ELECTRICAL POWER TO THE HEATING SYSTEM UPON ACTIVATION OF SUCH ALARM.
- 2. CARBON MONOXIDE DETECTORS, SMOKE ALARMS MUST BE INSTALLED AS PER MANUFACTURER'S INSTRUCTIONS.
- 3. EXHAUST FAN IN WASHROOM SHALL HAVE A MINIMUM EXHAUST RATE OF 50 CFM AND WITH A 100mm DIA. DUCT TO QUITDOOR
- DOORS SHALL BE PROVIDED WITH A GAP BENEATH, USING LOUVERED DOORS, OR INSTALLING A RETURN DUCT INLET FOR THE RETURN OF AIR FROM ALL ROOMS.

PROPOSED 2"X4" WOOD STUD WALL WITH 5/8" TYPE "X" (30 MINS.

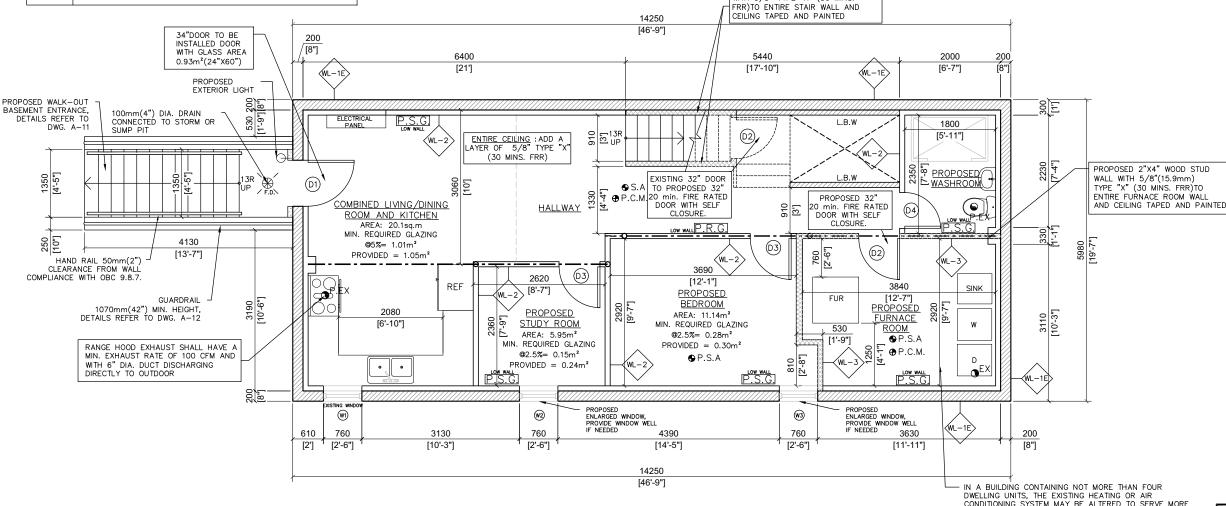


IN A BUILDING CONTAINING NOT MORE THAN FOUR DWELLING UNITS, THE EXISTING HEATING OR AIR CONDITIONING SYSTEM MAY BE ALTERED TO SERVE MORE THAN ONE DWELLING UNIT PROVIDED SMOKE ALARMS ARE INSTALLED IN EACH DWELLING UNIT AND PROVIDED A SMOKE DETECTOR IS INSTALLED IN THE SUPPLY OR RETURN AIR DUCT SYSTEM SERVING THE ENTIRE BUILDING WHICH WOULD TURN OFF THE FUEL SUPPLY AND ELECTRICAL POWER TO THE HEATING SYSTEM UPON ACTIVATION OF SILED PETECTOR

1 PROPOSED BASEMENT PLAN

	DOOR SCHEDULE					
NO.	SIZE (INCH)	SIZE (MM)	NOs.	TYPE	REMARKS	
D1	34"X80"	864X2032	1	EXTERIOR	PROPOSED	
D2	32"X80"	813X2032	2	INTERIOR	PROPOSED	
D3	32"X78"	813X1981	2	INTERIOR	PROPOSED	
D4	28"X78"	711X1981	1	INTERIOR	PROPOSED	

	WINDOW SCHEDULE				
NO.	SIZE (INCH)	SIZE (MM)	NOs.	GLAZING AREA	REMARKS
W1	30"X12"	762X305	1	0.12m²	EXISTING
W2	30"X20"	762X508	1	0.24m²	PROPOSED
W3	30"X24"	762X610	1	0.30m²	PROPOSED

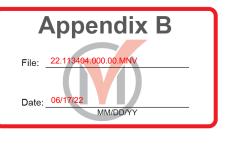

PREPARED BY: LAND& BUILDING EXPERTS 570 Alden Rd., Unit 6, Markham, ON. L3R 8N5 (647) 340-8649 landbuildex@gmail.com

(647) 546 6645 Introduce & Britain

PROFESSIONAL CLASSICAL CLA

PROJECT INFO:

30 STOCKPORT RD , CITY OF MARKHAM, ON, L6B0R2

DO NOT SCALE DRAWINGS.

The contractor must verify and accept responsibility for all dimensions and conditions on site and must notify the Designer/Engineer of any variations from the supplied drawings and informations before proceeding with the work. Construction must conform to all applicable codes and requirements of authorities having jurisdiction.

All drawings are the property of Land & Building Experts. and must not be reproduced with out written consent.

ALTERATION TO AN EXISTING SEMI-DETACHED DWELLING TO HAVE A SECOND SUITE IN THE BASEMENT

PROPOSED

BASEMENT PLAN

			SCALE AS INDICATED
	BUILDING PERMIT	DEC/24/21	DRAWN BY: K.T
	CLIENT REVIEW	DEC/20/21	CHECKED BY:
١.	ISSUED FOR	DATE	PROJECT NO.:


DWG. NO.

LEGEND			
EXISTING			
● EX	EXHAUST FAN		
⊕ S.A	SMOKE ALARM		
⊕ C.M.	CARBON MONOXIDE DETECTOR		
REF	REFRIGERATOR		
FUR	FURNACE	FURNACE	
Н	HOT WATER TANK		
S.G	SUPPLY AIR GRILLES		
R.G.	RETURN AIR GRILLES		
PROPOSED			
⊕ P.S.A	PROPOSED SMOKE ALARMS	INTERCONNECTED	
⊕P.C.M.	PROPOSED CARBON MONOXIDE DETECTOR	WITH ALL FLOORS	
●P.EX	PROPOSED EXHAUST FAN		


	WALL SCHEDULE
₩L-1E>	EXISTING 8"(203mm) POURED CONCRETE (WITH 12CI INSULATION), 2"X4"(50.8mmX101.6mm) WOOD STUDS @ 16"(406mm) O.C WITH PROPOSED \(\frac{1}{2}\)"(12.7mm) GYPSUM WALL BOARD , TAPED AND SANDED
WL-2	PROPOSED 2"X4"(50.8mmX101.6mm) WOOD STUD WALL WITH 1"(12.7mm) GYPSUM WALL BOARD BOTH SIDES, TAPED AND SANDED
₩ L-3	PROPOSED 2"X4"(50.8mmX101.6mm) WOOD STUD WALL WITH 5/8"(15.9mm) TYPE "X" (30 MINS. FRR)TO ENTIRE FURNACE ROOM WALL TAPED AND PAINTED

DOOR SCHEDULE					
NO.	SIZE (INCH)	SIZE (MM)	NOs.	TYPE	REMARKS
D5	30"X78"	762X1981	1	INTERIOR	PROPOSED

NOTE: All THE EXISTING AND PROPOSED SMOKE ALARMS AND CARBON MONOXIDE DETECTORS WILL BE INTERCONNECTED THROUGHOUT THE ENTIRE FLOORS

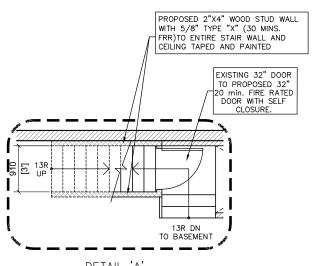

DETAIL 'A'

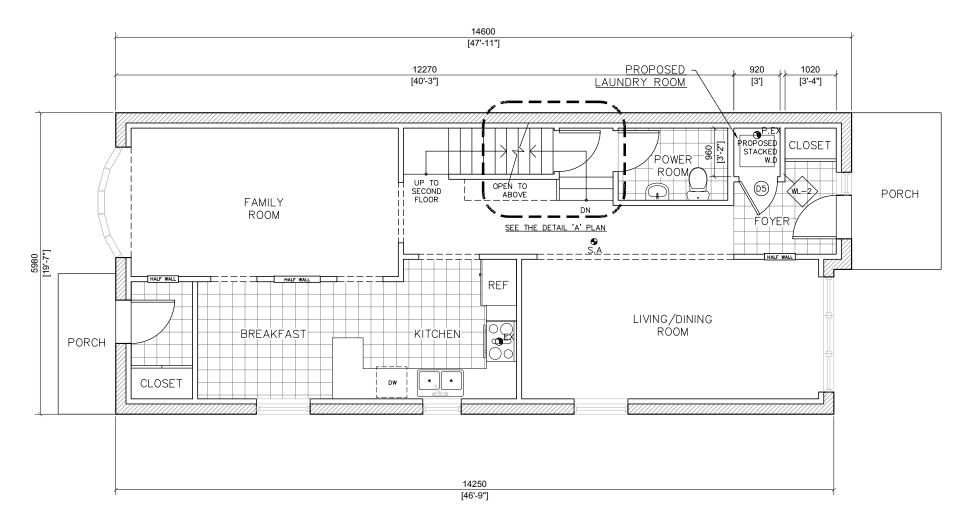





Appendix B

MM/DD/Y

File: 22.113404.000.00.MNV

570 Alden Rd., Unit 6, Markham, ON. L3R 8N5 (647) 340-8649 landbuildex@gmail.com

PROFESSIONAL TRANSPORTER TO THE PROPERTY OF TH

PROJECT INFO:

PROJECT NAME:

30 STOCKPORT RD , CITY OF MARKHAM, ON, L6B0R2

DO NOT SCALE DRAWINGS.

The contractor must verify and accept responsibility for all dimensions and conditions on site and must notify the Designer/Engineer of any variations from the supplied drawings and informations before proceeding with the work. Construction must conform to all applicable codes and requirements of authorities having jurisdiction.

All drawings are the property of Land & Building Experts. and must not be reproduced with out written consent.

ALTERATION TO AN EXISTING
SEMI-DETACHED DWELLING TO
HAVE A SECOND SUITE IN THE
BASEMENT

PROPOSED
FIRST FLOOR PLAN


A-6


		SCAL
BUILDING PERMIT	DEC/24/21	DRAV
CLIENT REVIEW	DEC/20/21	CHEC
ISSUED FOR	DATE	PROJ

	SCALE AS INDICATED	DWG
	DRAWN BY: K.T	
	CHECKED BY:	
1	PROJECT NO :	

LEGEND		
EXISTING		
● EX	EXHAUST FAN	
⊕ S.A	SMOKE ALARM	
⊕ C.M.	CARBON MONOXIDE DETECTOR	
REF	REFRIGERATOR	
FUR	FURNACE	
Н	HOT WATER TANK	
S.G.	SUPPLY AIR GRILLES	
R.G.	RETURN AIR GRILLES	
PROPOSED		
⊕ P.S.A	PROPOSED SMOKE ALARMS	INTERCONNECTE
⊕P.C.M.	PROPOSED CARBON MONOXIDE DETECTOR	WITH ALL FLOORS
● P.EX	PROPOSED EXHAUST FAN	

NOTE: All THE EXISTING AND PROPOSED SMOKE ALARMS AND CARBON MONOXIDE DETECTORS WILL BE INTERCONNECTED THROUGHOUT THE ENTIRE FLOORS

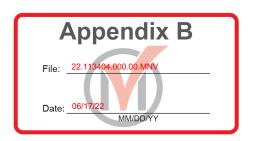

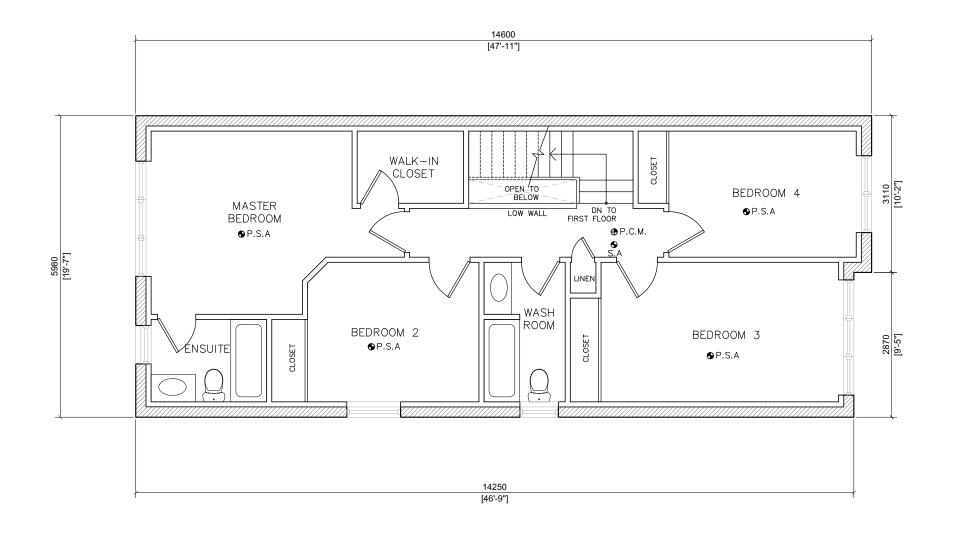

1 PROPOSED SECOND FLOOR PLAN
A-7 SCALE = 1:75

PREPARED BY:

LAND&
BUILDING
EXPERTS

570 Alden Rd., Unit 6, Markham, On. L3R 8N5
(647) 340-8649 | landbuildex@gmail.com

STAMP:



PROJECT INFO:

30 STOCKPORT RD , CITY OF MARKHAM, ON, L6B0R2

DO NOT SCALE DRAWINGS.

The contractor must verify and accept responsibility for all dimensions and conditions on site and must notify the Designer/Engineer of any variations from the supplied drawings and informations before proceeding with the work. Construction must conform to all applicable codes and requirements of authorities having jurisdiction.


All drawings are the property of Land & Building Experts. and must not be reproduced with out written consent.


ALTERATION TO AN EXISTING SEMI-DETACHED DWELLING TO HAVE A SECOND SUITE IN THE BASEMENT

PROPOSED
SECOND FLOOR PLAN

			SCALE AS IN
2	BUILDING PERMIT	DEC/24/21	DRAWN BY:
1	CLIENT REVIEW	DEC/20/21	CHECKED B
_			DROJECT NO

DWG. NO. **A-7**

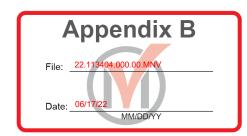

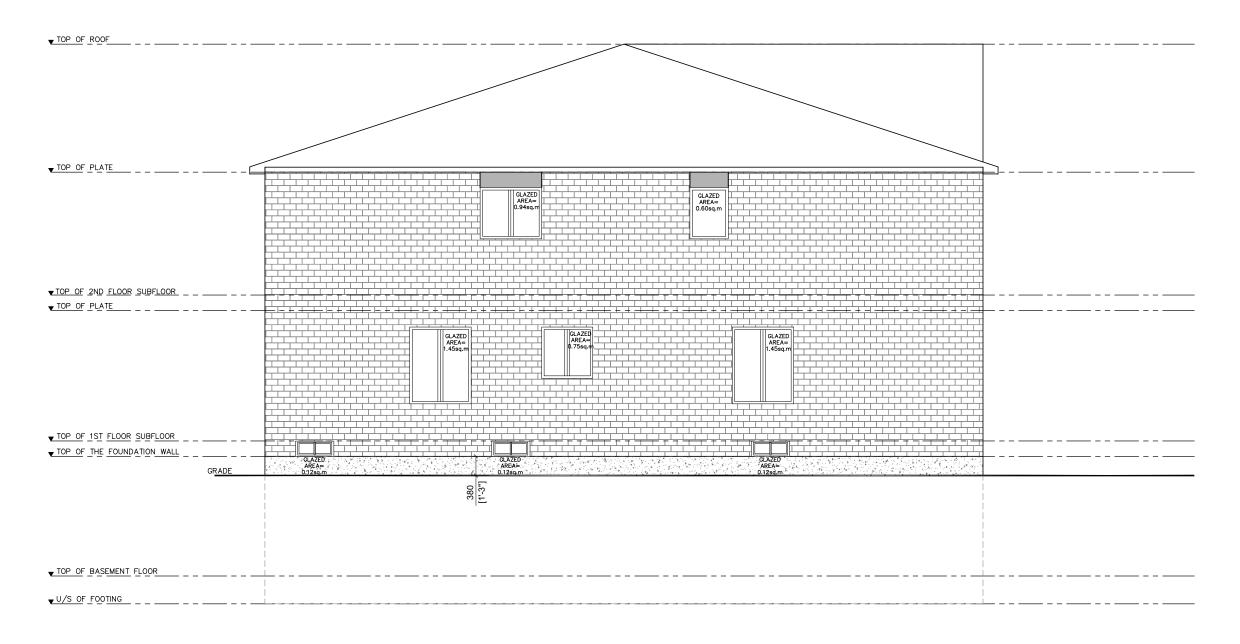

UNPROTECTED OPENINGS GLAZED OPENINGS IN EXPOSING BUILDING FACE TO	ble 9.10.15.4.
TOTAL WALL AREA	85.77m²
LIMITING DISTANCE	1200mm @7.0%
MAX. ALLOWABLE OPENINGS	6.00m²
TOTAL OPENING PROVIDED	5.55m²

PREPARED BY: BUILDING 570 Alden Rd., Unit 6, Markham, ON. L3R 8N5 (647) 340-8649 landbuildex@gmail.com



PROJECT INFO:

30 STOCKPORT RD, CITY OF MARKHAM, **ON, L6B0R2**

DO NOT SCALE DRAWINGS.

The contractor must verify and accept responsibility for all dimensions and conditions on site and must notify the Designer/Engineer of any variations from the supplied drawings and informations before proceeding with the work. Construction must conform to all applicable codes and requirements of authorities having jurisdiction.

All drawings are the property of Land & Building Experts. and must not be reproduced with out written consent.


PROJECT NAME:	
AITEDAT	


ALTERATION TO AN EXISTING SEMI-DETACHED DWELLING TO HAVE A SECOND SUITE IN THE **BASEMENT**

DRAWING TITLE: EXISTING **SOUTH ELEVATION(LEFT)**

		SCALE AS INDICATED
BUILDING PERMIT	DEC/24/21	DRAWN BY: K.T
CLIENT REVIEW	DEC/20/21	CHECKED BY:
1001150 500	DATE	PROJECT NO :

$\binom{1}{1}$	EXISTING	SOUTH	ELEVATION((LEFT)
A-8	SCALE = 1:75			

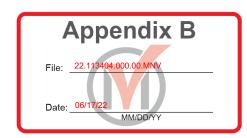


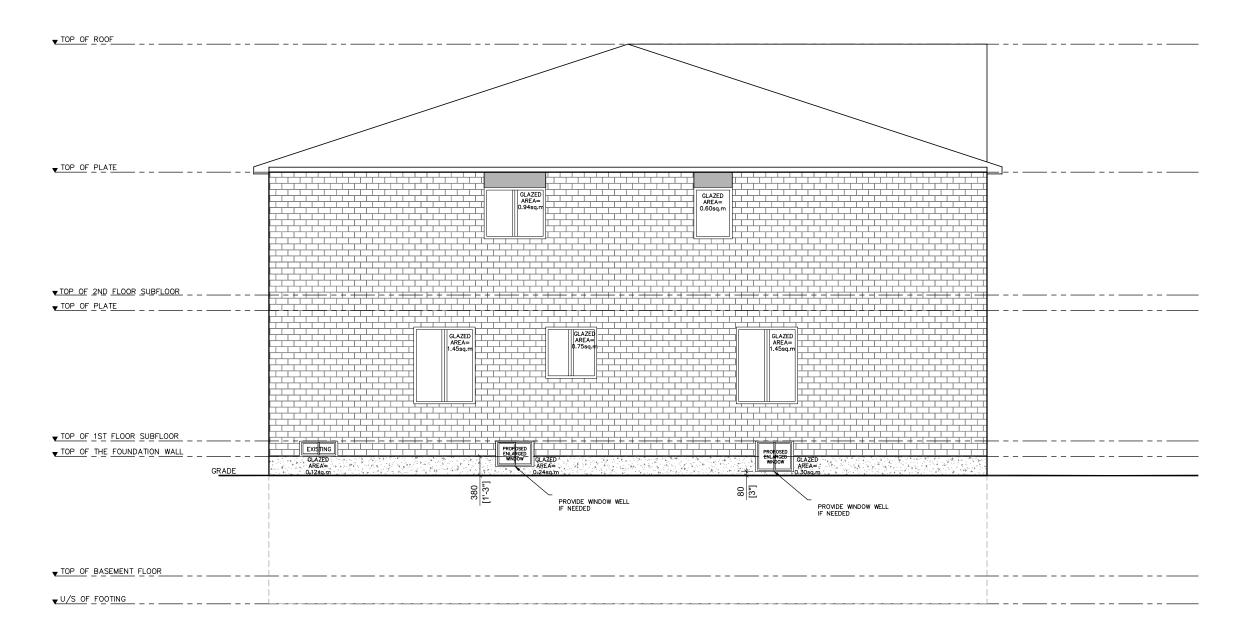

UNPROTECTED OPENINGS GLAZED OPENINGS IN EXPOSING BUILDING FACE Table 9.10.15.4. TOTAL WALL AREA 85.77m² LIMITING DISTANCE MAX. ALLOWABLE OPENINGS 6.00m² TOTAL OPENING PROVIDED 5.85m²

1200mm @7.0%

PREPARED BY: BUILDING 570 Alden Rd., Unit 6, Markham, ON. L3R 8N5 (647) 340-8649 landbuildex@gmail.com

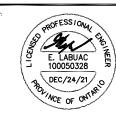

PROJECT INFO:

30 STOCKPORT RD, CITY OF MARKHAM, **ON, L6B0R2**

DO NOT SCALE DRAWINGS.

The contractor must verify and accept responsibility for all dimensions and conditions on site and must notify the Designer/Engineer of any variations from the supplied drawings and informations before proceeding with the work. Construction must conform to all applicable codes and requirements of authorities having jurisdiction.

All drawings are the property of Land & Building Experts. and must not be reproduced with out written consent.

ALTERATION TO AN EXISTING
SEMI-DETACHED DWELLING TO
HAVE A SECOND SUITE IN THE
BASEMENT


DRAWING TITLE: PROPOSED **SOUTH ELEVATION(LEFT)**


		SCALE AS INDICATED	
BUILDING PERMIT	DEC/24/21	DRAWN BY: K.T	
CLIENT REVIEW	DEC/20/21	CHECKED BY:	
ISSUED FOR	DATE	PROJECT NO :	

A-9

PROPOSED SOUTH ELEVATION(LEFT)

A-9 SCALE = 1:75

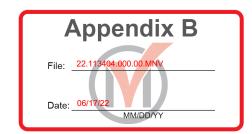

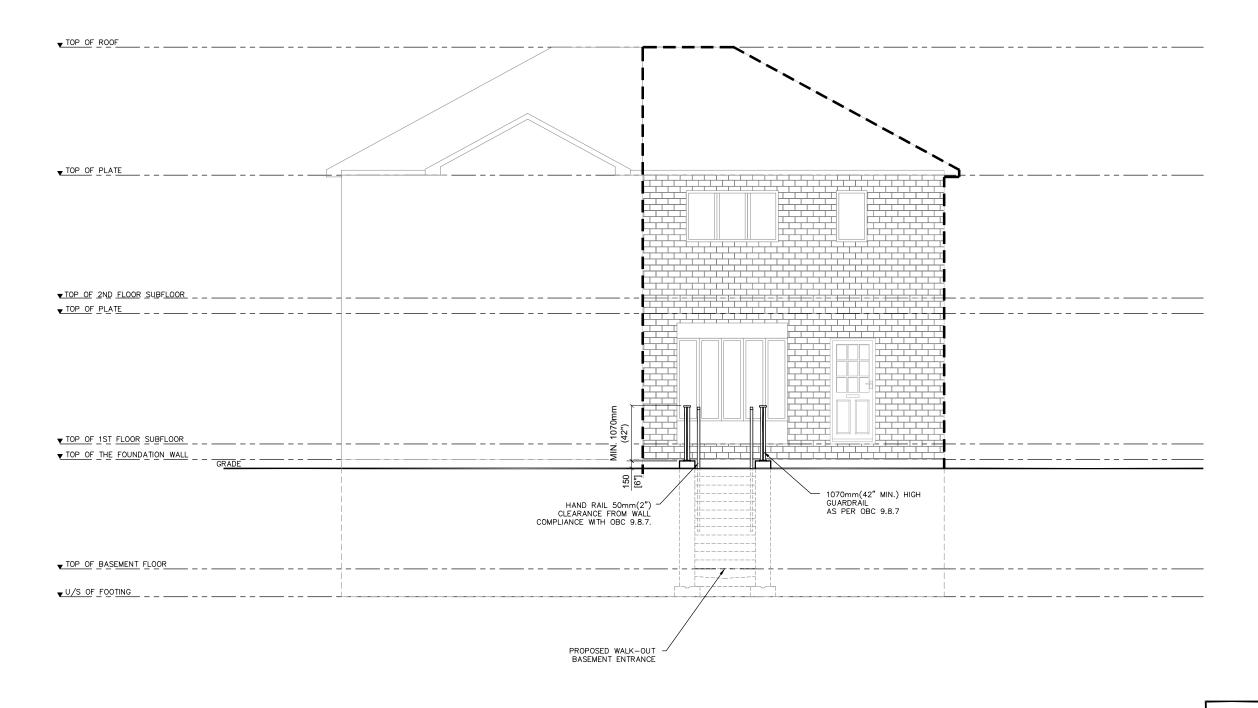

PREPARED BY: LAND& BUILDING 570 Alden Rd., Unit 6, Markham, ON. L3R 8N5 (647) 340-8649 landbuildex@gmail.com



PROJECT INFO:

30 STOCKPORT RD, CITY OF MARKHAM, ON, L6B0R2

DO NOT SCALE DRAWINGS.

The contractor must verify and accept responsibility for all dimensions and conditions on site and must notify the Designer/Engineer of any variations from the supplied drawings and informations before proceeding with the work. Construction must conform to all applicable codes and requirements of authorities having jurisdiction.


All drawings are the property of Land & Building Experts. and must not be reproduced with out written consent.


ALTERATION TO AN EXISTING SEMI-DETACHED DWELLING TO HAVE A SECOND SUITE IN THE BASEMENT


DRAWING TITLE: PROPOSED WEST ELEVATION(REAR)

		SCALE AS INDICATED	DWG. NO.
BUILDING PERMIT	DEC/24/21	DRAWN BY: K.T	A 10
CLIENT REVIEW	DEC/20/21	CHECKED BY:	H-TO
ISSUED FOR	DATE	PROJECT NO.:	

1 PROPOSED WEST ELEVATION(REAR)
A-10 SCALE = 1:75

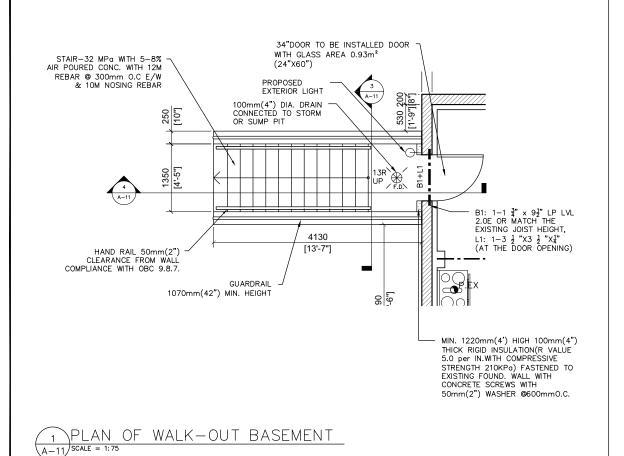

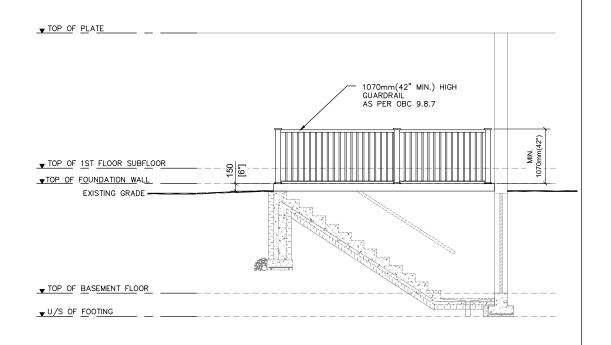


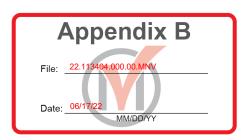

ELEVATION OF WALK-OUT BASEMENT

HAND RAIL 50mm(2") CLEARANCE FROM WALL COMPLIANCE WITH OBC 9.8.7. 1070mm(42" MIN.) HIGH GUARDRAIL AS PER OBC 9.8.8.1 254mm(10")32 MPa WITH 5-8% AIR POURED CONC. WALL WITH 15M @ 400mm O.C. E/W 100mm(4") THICK RIGID INSULATION(R VALUE 5.0 per IN.WITH GRADE COMPRESSIVE STRENGTH210KPa) ON 100mm(4") GRAVEL COMPACTED ON 100mm(4") DIA. DRAIN 100mm(4") THICK RIGID CONNECTED TO EXISTING WEEPING TILE OR SUMP INSULATION(R VALUE 5.0 per IN. WITH COMPRESSIVE STRENGTH 210KPa) ON 100mm(4") GRAVEL COMPACTED ON UNDISTURBED SOIL 100mm(4") THICK CONCRETE SLAB WITH 32MPA. 5-8% AIR WITH 12M @ 400mm O.C E/W 100mm(4")WEEPING TILE WITH 50mm(2") COVER W/150mm(6")STONE COVER CONNECT TO EXISTING 500mm(20")X200mm(8") 20 MPa POURED CONC. STRIP FOOTING WITH 2–15M LONGITUDINAL BAR & 15M TRANSVERSE BAR @400mm O.C.

SECTION -1

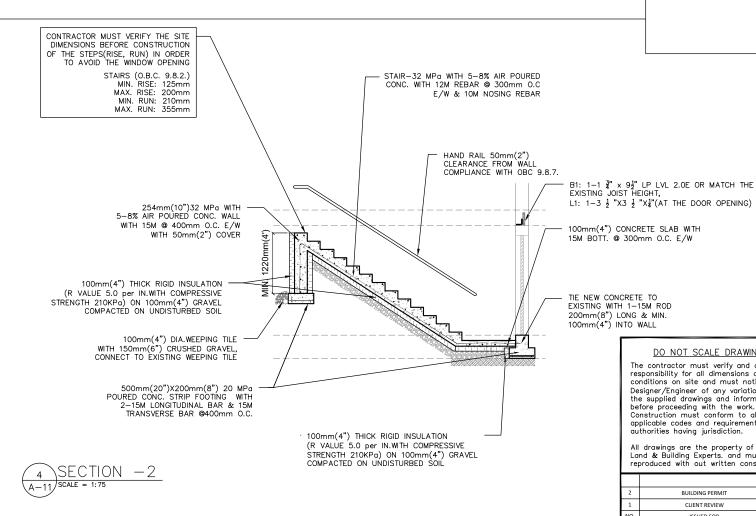

REPARED BY: LAND& BUILDING 570 Alden Rd., Unit 6, Markham, ON. L3R 8N5 (647) 340-8649 landbuildex@gmail.com



PROJECT INFO:

ROJECT NAME:

30 STOCKPORT RD CITY OF MARKHAM, **ON, L6B0R2**

DO NOT SCALE DRAWINGS.

The contractor must verify and accept responsibility for all dimensions and conditions on site and must notify the Designer/Engineer of any variations from the supplied drawings and informations before proceeding with the work. Construction must conform to all applicable codes and requirements of authorities having jurisdiction.

All drawings are the property of Land & Building Experts. and must not be reproduced with out written consent.


ALTERATION TO AN EXISTING

SEMI-DETACHED DWELLING TO HAVE A SECOND SUITE IN THE **BASEMENT**


RAWING TITLE

SECTION DRAWING

		SCALE AS INDICATED	DWG
BUILDING PERMIT	DEC/24/21	DRAWN BY: K.T	
CLIENT REVIEW	DEC/20/21	CHECKED BY:	Ι.
ISSUED FOR	DATE	PROJECT NO.:	

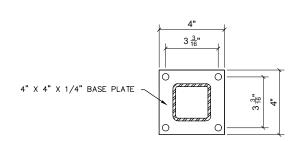

1 BASE PLATE DETAIL TOP VIEW A-12 SCALE = N.T.S.

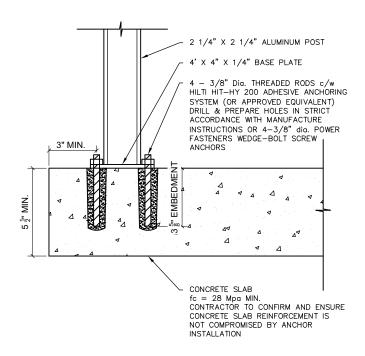


2 ALUMINUM POST ANCHORAGE DETAIL A-12 SCALE = N.T.S.

SECTION THROUGH CONCRETE SLAB

NOTE

- ALUMINIUM POST AND BASE PLATE PROPRIETARY & DESIGNED BY
 OTHERS
- 2. RESPONSIBILITY FOR BASE PLATE STRUCTURE TO SUPPORT GUARDRAIL LOADING BY OTHERS

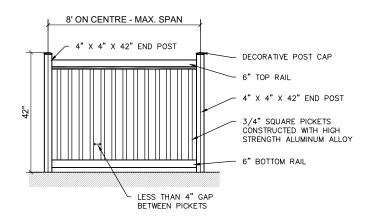

3 HORIZONTAL BALCONY RAILING (PICKET ST) A-12 SCALE = N.T.S.

NOTE:

ALUMINIUM POST, DECORATIVE POST CAP, TOP RAIL, BOTTOM RAIL, RAILING PICKETS PROPRIETARY & DESIGNED BY OTHERS

DRAWINGS:

SHOP DRAWINGS TO CONFORM TO CSA CAN3-S16.1-M INDICATE WELDS USING WELDING SYMBOLS TO CSA W59.2-M. ALL DIMENSIONS WILL BE VERIFIED BY MANUFACTURER ON SITE PRIOR TO FABRICATION.

APPLICABLE CODES:

MANUFACTURE AND INSTALLATION OF GUARDS AND THEIR COMPONENTS SHALL BE IN ACCORDANCE WITH THE ONTARIO BUILDING CODE AND THE FOLLOWING APPLICABLE STANDARDS:

CAN/CSA-S157-05/S157.1-05 STRENGTH DESIGN IN ALUMINUM

CSA W59.2-M1991(R2008) WELDED ALUMINUM CONSTRUCTION

CAN/CGSB-93.1-M85- SHEET, ALUMINUM ALLOY, PREFINISHED

CSA S16-01 DESIGN OF STEEL STRUCTURES

CAN/CSA-A23.3-04 DESIGN OF CONCRETE STRUCTURES

CAN/CSA-A371-04(R2010) MASONRY CONSTRUCTION OF BUILDINGS

CSA S304.1-04(R2010) DESIGN OF MASONRY STRUCTURES

CSA A23-1-09 CONCRETE MATERIAL AND METHOD OF CONCRETE CONSTRUCTION

CSA W59-03(R2008) WELDED STEEL CONSTRUCTION (METAL ARC WELDING)

CSA W59.2-M1991(R2008) WELDED ALUMINUM CONSTRUCTION

CSA W47.2-11 CERTIFICATION OF COMPANIES FOR FUSION WELDING OF ALUMINUM

DESIGN LOADS

THE INSTALLED GUARDRAIL SYSTEM SHALL WITHSTAND ALL LOADS CONFORMING TO TESTING TO CAN3—S157—M, ASTM E935 STANDARD TEST METHODS FOR PERFORMANCE OF PERMANENT METAL RAILING SYSTEMS AND RAILS FOR BUILDINGS, AND ASTM E894 STANDARD TEST METHOD FOR ANCHORAGE OF PERMANENT METAL RAILING SYSTEMS AND RAILS FOR BUILDINGS.

ALL DESIGN LOADS TO CONFORM TO ONTARIO BUILDING CODE, SECTION 4.1 STRUCTURAL LOADS AND PROCEDURES.

4.1.5.14 (1): THE MINIMUM SPECIFIED HORIZONTAL LOAD APPLIED INWARD AND OUTWARD ON THE TOP OF EVERY REQUIRED GUARD SHALL BE:

4.1.5.14(1C): 0.75 KN/M(50LB/FT) OR A CONCENTRATED LOAD OF 1.0 KN(225 LB) APPLIED AT ANY POINT.

4.1.5.14(2): INDIVIDUAL ELEMENTS WITHIN THE GUARD, INCLUDING SOLID PANELS AND PICKETS, DESIGNED FOR A CONCENTRATED LOAD OF 0.5 KN(113LB) AT ANY POINT IN THE ELEMENT.

4.1.5.14 (3): THE LOADS REQUIRED IN SENTENCE (2) NEED NOT BE CONSIDERED TO ACT SIMULTANEOUSLY WITH THE LOADS PROVIDED FOR IN SENTENCES (1) AND (4).

4.1.5.14 (4): THE SPECIFIED LOAD APPLIED VERTICALLY AT THE TOP OF EVERY REQUIRED GUARD 1.5 KN/M (100 LB/FT) AND NEED NOT BE CONSIDERED TO ACT SIMULTANEOUSLY WITH HORIZONTAL LOAD PROVIDED FOR IN SENTENCE (1).

MATERIAL SPECIFICATIONS:

THE CONCRETE STRENGTH IS ASSUMED TO BE NOT LESS THAN 28 MPA.

EXTRUDED POSTS SHALL BE 6005-T6 ALUMINUM ALLOY OR

ACCEPTABLE EQUIVALENT.

ALL OTHER MEMBERS TO BE 6063-T6 ALUMINUM ALLOY OR

ACCEPTABLE EQUIVALENT.

FORMED SHAPES (PANEL) SHALL BE ALLOY 3003-H14 OR

ACCEPTABLE EQUIVALENT.

FLAT ALUMINUM PANEL SHALL BE ALLOY 5052-H32 OR

ACCEPTABLE EQUIVALENT.

ANCHOR BOLTS USED ARE 304 S S. THREADED RODS 12MM OR

ACCEPTABLE EQUIVALENT.

ANCHORS:

HILTI CHEMICAL ADHESIVE SYSTEM HY-200 OR

ACCEPTABLE EQUIVALENT

EPCON ACRYLIC A7 EPOXY ANCHORING SYSTEM OR

ACCEPTABLE EQUIVALENT

ANCHORS FOR MASONRY WALLS SHALL BE ALL SLEEVE ANCHORS BY HILTI OR

ACCEPTABLE EQUIVALENT

ALL SCREWS FOR FASTENING ALUMINUM MEMBERS SHALL BE CORROSIVE RESISTANT SELF—TAPPING TEKS SCREWS, PAINTED TO MATCH COLOR. ALL EXPOSED SCREWS AND FASTENERS SHALL BE 304 STAINLESS STEEL OR ACCEPTABLE FOLIVALENT.

FINISH:

FINISHES TO AAMA 2604 AND 2605

FINISH TYPE: POLYESTER POWDER COATING COLOR

GLASS: TO BE SELECTED BY OWNER

FRAME: TO BE SELECTED BY OWNER

ALL TOUCH-UP SHALL BE TO THE MANUFACTURER'S TOUCH-UP PROCEDURE.

FABRICATION

TO COMPLY WITH ASTM E985 STANDARD SPECIFICATION FOR PERMANENT METAL GUARDRAIL SYSTEMS AND RAILS FOR BUILDINGS FABRICATION PRACTICES SHALL FOLLOW THOSE FOR STEEL, AS IN CSA W59-03(2008), CSA S16-09 EXCEPT AS OTHERWISE MODIFIED BY CSA-CAN3-5157-M83.

WELDING OPERATORS AND PROCEDURES USED SHALL BE QUALIFIED TO CSA STANDARD W47.2.

RAILING COMPONENTS SHOULD ACCOMMODATE THERMAL MOVEMENT WITHOUT ADVERSE EFFECTS TO THE RAILING SYSTEM

THE RAILING MEMBERS SHOULD BE CONNECTED TO THE RAILING IN FRAME IN SUCH A FASHION THAT ARE NOT FREE TO RATTLE UNDER WIND OR ANY OTHER LOADING.

ALL WELDING SHALL BE DONE WITH GAS METAL ARC WELDING (MIG).

<u>INSTALLATION</u>

ALUMINUM, WITHOUT FINISH COAT, IN CONTACT WITH CONCRETE AND/OR STEEL SHALL BE SEPARATED WITH 1MM THICK NEOPRENE GASKET

AMBIENT TEMPERATURE DURING THE INSTALLATION OF THE RAILING SHALL BE BETWEEN -10°C AND 33 $^{\circ}\text{C}.$

GUARDRAILS SHALL BE ANCHORED TO THE BALCONY FLOOR SLAB AT EACH POST WITH A MINIMUM OF TWO ANCHORS, 12MM IN DIAMETER.

TORQUE FOR 10MM ANCHORS 21NM

TORQUE FOR 12MM ANCHORS 42NM

CORNER POST AT 900 ANGLE, CAN BE SECURED WITH ONLY ONE ANCHOR

MINIMUM EMBEDMENT OF THE ANCHOR INTO THE SLAB SHALL BE 85 $_{\rm MM}$

Appendix B File: 22.113404.000.00.MNV Date: 06/17/22 MM/DD/YY

REPARED BY: LAND& BUILDING EXPERTS 570 Alden Rd., Unit 6, Markham, ON. L3R 8N5 (647) 340-8649 landbuildex@gmail.com

STAMP



PROJECT INFO:

30 STOCKPORT RD , CITY OF MARKHAM, ON, L6B0R2

DO NOT SCALE DRAWINGS.

The contractor must verify and accept responsibility for all dimensions and conditions on site and must notify the Designer/Engineer of any variations from the supplied drawings and informations before proceeding with the work. Construction must conform to all applicable codes and requirements of authorities having jurisdiction.

All drawings are the property of Land & Building Experts. and must not be reproduced with out written consent.

PROJECT NAME:

ALTERATION TO AN EXISTING SEMI-DETACHED DWELLING TO HAVE A SECOND SUITE IN THE BASEMENT

DRAWING TITLE:

GUARD SPECIFICATION

			SCALE AS INDICATED	DWG. NO.
	BUILDING PERMIT	DEC/24/21	DRAWN BY: K.T	
	CLIENT REVIEW	DEC/20/21	CHECKED BY:	A
	ISSUED FOR	DATE	PROJECT NO.:	