### Memorandum to the City of Markham Committee of Adjustment

August 01, 2023

File: A/114/22

Address: 67 Babcombe Drive, Thornhill
Applicant: Contempo Studio (Marin Zabzuni)
Hearing Date: Wednesday, August 16, 2023

The following comments are provided on behalf of the West Team. The applicant is requesting relief from the following "Third Density Special Residential – (SR3)" zone requirements under By-law 1767, as amended, as they relate to a proposed two-storey detached dwelling. The variances requested are to permit:

#### a) By-law 100-90, Section 1.2(i):

a building height of 8.54 meters (22.01 feet), whereas the By-law permits a maximum flat roof building height of 8.0 meters (26.24 feet);

### b) By-law 100-90, Section 1.2(iii):

a maximum building depth of 21.36 metres (70.07 feet), whereas the By-law permits a maximum building depth of 16.8 meters (55.12 feet);

#### c) <u>By-law 1767, Section 9(i):</u>

a south side yard roof encroachment of 98 inches (2.48 metres), whereas the Bylaw permits a maximum encroachment of no more than 18 inches (0.45 metres) into the required side yard setback;

#### d) By-law 1767, Section 12 (iv)(a):

a minimum front yard setback of 33.4 feet (10.18 metres), whereas the By-law requires that the front yard setback of a dwelling to be erected between two existing dwellings shall comply with the corresponding yards of the two existing dwellings being 42.7 feet (13.01 metres);

#### e) By-law 1767, Section 18(ii)(b):

a lot coverage of 36.2 percent, whereas the By-law requires a maximum lot coverage of 33 1/3 percent; and

#### f) By-law 100-90, Section 1.2 (vi):

a floor area ratio of 49.4 percent, whereas the By-law permits a maximum floor area ratio of 47 percent.

#### **BACKGROUND**

#### **Property Description**

The 1,392.98 m² (14,993.91 ft²) subject property is located on the west side of Babcombe Drive, north of Steeles Avenue East and east of Bayview Avenue. There is an existing 205.27 m² (2,209.50 ft²) one-storey detached dwelling on the subject property with mature vegetation located in the side and rear yards. The surrounding area is undergoing a transition with newer dwellings being developed as infill developments.

### Proposal

The applicant is proposing to construct a two-storey detached dwelling with an integral garage with an approximate gross floor area of 688.59 m<sup>2</sup> (7,412 ft<sup>2</sup>).

### Official Plan and Zoning

Official Plan 2014 (partially approved on November 24/17, and updated on April 9/18)

The Official Plan designates the subject property "Residential Low Rise", which provides for low rise housing forms including single detached dwellings. Section 8.2.3.5 of the Official Plan outlines infill development criteria for the "Residential Low Rise" designation with respect to height, massing, and setbacks. These criteria are established to ensure that infill development is appropriate for the site and generally consistent with the zoning requirements for adjacent properties and properties along the same street, while accommodating a diversity of building styles. In considering applications for development approval in a "Residential Low Rise" area, which includes variances, development is required to meet the general intent of these development criteria. Regard shall also be had for the retention of existing trees and vegetation.

#### Zoning By-Law 1767

The subject property is zoned "Third Density Special Residential— (SR3)" under By-law 1767, as amended, which permits one single detached dwelling per lot.

#### Residential Infill Zoning By-law 100-90

The subject property is also subject to the Residential Infill Zoning By-law 100-90. The intent of this By-law is to ensure the built form of new residential construction will maintain the character of existing neighbourhoods. It specifies development standards for building depth, garage projection, garage width, net floor area ratio, height, yard setbacks and number of storeys. The proposed development does not comply with the infill By-law requirements with respect to building height, building depth, and floor area ratio.

#### **Zoning Preliminary Review (ZPR) Undertaken**

The owner has completed a Zoning Preliminary Review (ZPR) on May 18, 2023 to confirm the variances required for the proposed development.

#### **COMMENTS**

The Planning Act states that four tests must be met in order for a variance to be granted by the Committee of Adjustment:

- a) The variance must be minor in nature;
- b) The variance must be desirable, in the opinion of the Committee of Adjustment, for the appropriate development or use of land, building or structure:
- c) The general intent and purpose of the Zoning By-law must be maintained;
- d) The general intent and purpose of the Official Plan must be maintained.

#### **Increases Maximum Floor Area Ratio Variance**

The applicant is requesting relief to permit a floor area ratio of 49.4 percent, whereas a maximum floor area ratio of 47 percent is permitted. The variance will facilitate the construction of a two-storey detached dwelling with a floor area of 688.59 m<sup>2</sup> (7,412 ft<sup>2</sup>), whereas the By-law a maximum floor area of 654.96 m<sup>2</sup> (7,050 ft<sup>2</sup>) is permitted. This represents an increase of approximately 33.63 m<sup>2</sup> (361.99 ft<sup>2</sup>).

Floor Area Ratio is a measure of the interior square footage of the dwelling as a percentage of the net lot area however; it is not a definitive measure of the mass of the

dwelling, since it does not include "open to below" areas that may exist within the dwelling (e.g. two-storey foyers, atriums and/or stairs).

The proposed increase in floor area represents a relatively minor deviation from the Bylaw requirement and is in keeping with the intended scale of residential infill developments for this neighbourhood. Staff are satisfied that the requested floor area ratio will not result in an overdevelopment of the site, and are of the opinion that the variance is generally consistent with what the By-law permits.

#### **Increased Maximum Lot Coverage Variance**

The applicant is requesting relief for a maximum lot coverage of 36.2 percent, whereas a maximum floor area ratio of 33 1/3 percent is permitted. The proposed lot coverage includes the accessory building in the rear which adds approximately 36.77 m² (395.78 ft²) to the overall building area. Excluding the accessory building, the detached dwelling a lot coverage of 32.84 percent and would comply with the by-law requirement. Given that the main dwelling is below the by-law requirement, staff are of the opinion that the proposed increase in lot coverage will not significantly add to the scale and massing of the dwelling and the resultant dwelling is generally consistent with what the by-law permits.

#### **Increased Maximum Building Depth Variance**

The applicant is requesting relief to permit a maximum building depth of 21.36 m (70.07 ft.), whereas a maximum building depth of 16.8 m (55.11 ft.) is permitted. This represents an increase of approximately 4.56 m (14.96 ft.).

Building depth is measured based on the shortest distance between two lines, both parallel to the front lot line, one passing though the point on the dwelling which is the nearest and the other through the point on the dwelling which is the farthest from the front lot line. This variance is being requested to facilitate a building footprint that is irregular in shape. Staff note that approximately 0.76 m (2.49 ft.) of the proposed increased depth is attributed to the front covered porch and 2.3 m (7.54 ft.) for the projection of the rear covered deck. The main component of the building, excluding the aforementioned projections has a depth of 18.3 m (60.03 ft.). As adequate amenity space is being provided in the rear yard, staff are of the opinion that the variance meets the general intent and purpose of the Zoning By-law.

#### Increase in Maximum Building Height

The applicant is requesting relief to permit a maximum building height of 8.54 m (28.01 ft.), whereas a maximum building height of 8.0 m (26.24 ft.) for a flat roof is permitted. This represents an increase of 0.54 m (1.77 ft.).

The By-law calculates building height using the vertical distance of building or structure measured between the level of the crown of the street and highest point of the roof surface. It should be noted that the proposed grade of the front of the house is approximately 0.4 m (1.31ft) above the crown of road. Staff considers the proposed increase in height to be consistent and compatible with existing infill development along Balcombe Drive. Staff further note the existing trees on the property will provide screening to mitigate any visual impacts to the streetscape or neighbouring properties.

Consequently, staff are of the opinion the proposed building height will not adversely impact the character of the neighbourhood and is appropriate for the subject property.

#### Reduced Front Yard Setback Variance

The applicant is requesting relief from the Zoning By-law to permit a minimum front yard setback of 33.4 ft. (10.18 m), whereas the By-law requires that the front yard setback of a dwelling to be erected between two existing dwellings shall comply with the corresponding yards of the two existing dwellings being 42.7 feet (13.01 m). Given that the main front wall of the building is generally consistent with the established front yard setback pattern on the street or rear yard setback pattern, staff have does not anticipate any adverse impacts as a result of the requested variance and therefore have no concerns.

#### **Increased Maximum Eaves Encroachment Variance**

The applicant is requesting a maximum eaves encroachment of 98 in (2.48 m) into the south side yard, whereas a maximum eaves encroachment of no more than 18 in (0.45 m) is permitted. This represents an increase of 79.92 in (2.03 m). Staff are of the opinion that since the requested variance maintains the permitted side yard setback, it will not add to the overall massing of the building. Staff are of the opinion that the requested variance is appropriate for the development of the site.

#### Metrolinx Requirements

The subject property is located within 300 m of Metrolinx's Bala Subdivision which carries Metrolinx's Stouffville GO Train service. Metrolinx provided comments on this application on June 23, 2022 (Appendix "C"), requiring that an environmental easement is provided in accordance with Section 3.9 of the Federation of Canadian Municipalities and Railway Associate of Canada's Guidelines for New Development in Proximity to Railway Operations. The environmental easement provides clear notification to those who may acquire an interest in the subject property and reduces the potential for future land use conflicts. The environmental easement shall be registered on title of the subject property.

Staff recommend that the proposed development is subject to the associated condition of approval provided in Appendix "A".

#### **PUBLIC INPUT SUMMARY**

No written submissions were received as of August 14, 2023. It is noted that additional information may be received after the writing of the report, and the Secretary-Treasurer will provide information on this at the meeting.

#### CONCLUSION

Planning Staff have reviewed the application with respect to Section 45(1) of The *Planning Act*, R.S.O. 1990, c. P.13, as amended, and are of the opinion that the variance request meets the four tests of the *Planning Act* and have no objection. Staff recommend that the Committee consider public input in reaching a decision.

The onus is ultimately on the applicant to demonstrate why they should be granted relief from the requirements of the zoning by-law, and how they satisfy the tests of the Planning Act required for the granting of minor variances.

Please refer to Appendix "A" for conditions to be attached to any approval of this application.

PREPARED BY:	

Brashanthe Manoharan, Planner II, East District

**REVIEWED BY:** 

Auch Count

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Rick Cefaratti, MCIP, RPP Senior Planner II, West District


### APPENDIX "A" CONDITIONS TO BE ATTACHED TO ANY APPROVAL OF FILE A/114/22


- 1. The variances apply only to the proposed development for as long as it remains.
- 2. That the variances apply only to the proposed development, in substantial conformity with the plans attached as Appendix "B" to this Staff Report, and that the Secretary-Treasurer receive written confirmation from the Director of Planning and Urban Design or designate that this condition has been fulfilled to his or her satisfaction.
- 3. That the Owner satisfies the requirements of Metrolinx, financial or otherwise, as indicated in their letter to the Secretary-Treasurer, attached as Appendix "C" to this Staff Report, and that the Secretary-Treasurer receive written confirmation that this condition has been fulfilled to the satisfaction of Metrolinx.
- 4. Submission of a Tree Assessment and Preservation Plan, prepared by a qualified arborist in accordance with the City's Streetscape Manual (2009), as amended, to be reviewed and approved by the Director of Planning and Urban Design, or their designate, and that the Secretary-Treasurer receive written confirmation that this condition has been fulfilled to the satisfaction of the Director of Planning and Urban Design, or their designate.
- 5. That tree replacements be provided and/or tree replacement fees be paid to the Director of Planning and Urban Design, or their designate, if required, in accordance with the Tree Assessment and Preservation Plan, and that the Secretary-Treasurer receive written confirmation that this condition has been fulfilled to the satisfaction of the Director of Planning and Urban Design, or their designate.
- 6. That prior to the commencement of construction or demolition, tree protection be erected and maintained around all trees on site, including street trees, in accordance with the City's Streetscape Manual (2009), as amended, and inspected by the Tree Preservation Technician, or their designate, and that the Secretary-Treasurer receive written confirmation that this condition has been fulfilled to the satisfaction of the Director of Planning and Urban Design, or their designate.

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CONDITIONS PREPARED BY:

Brashanthe Manoharan, Planner II, East District



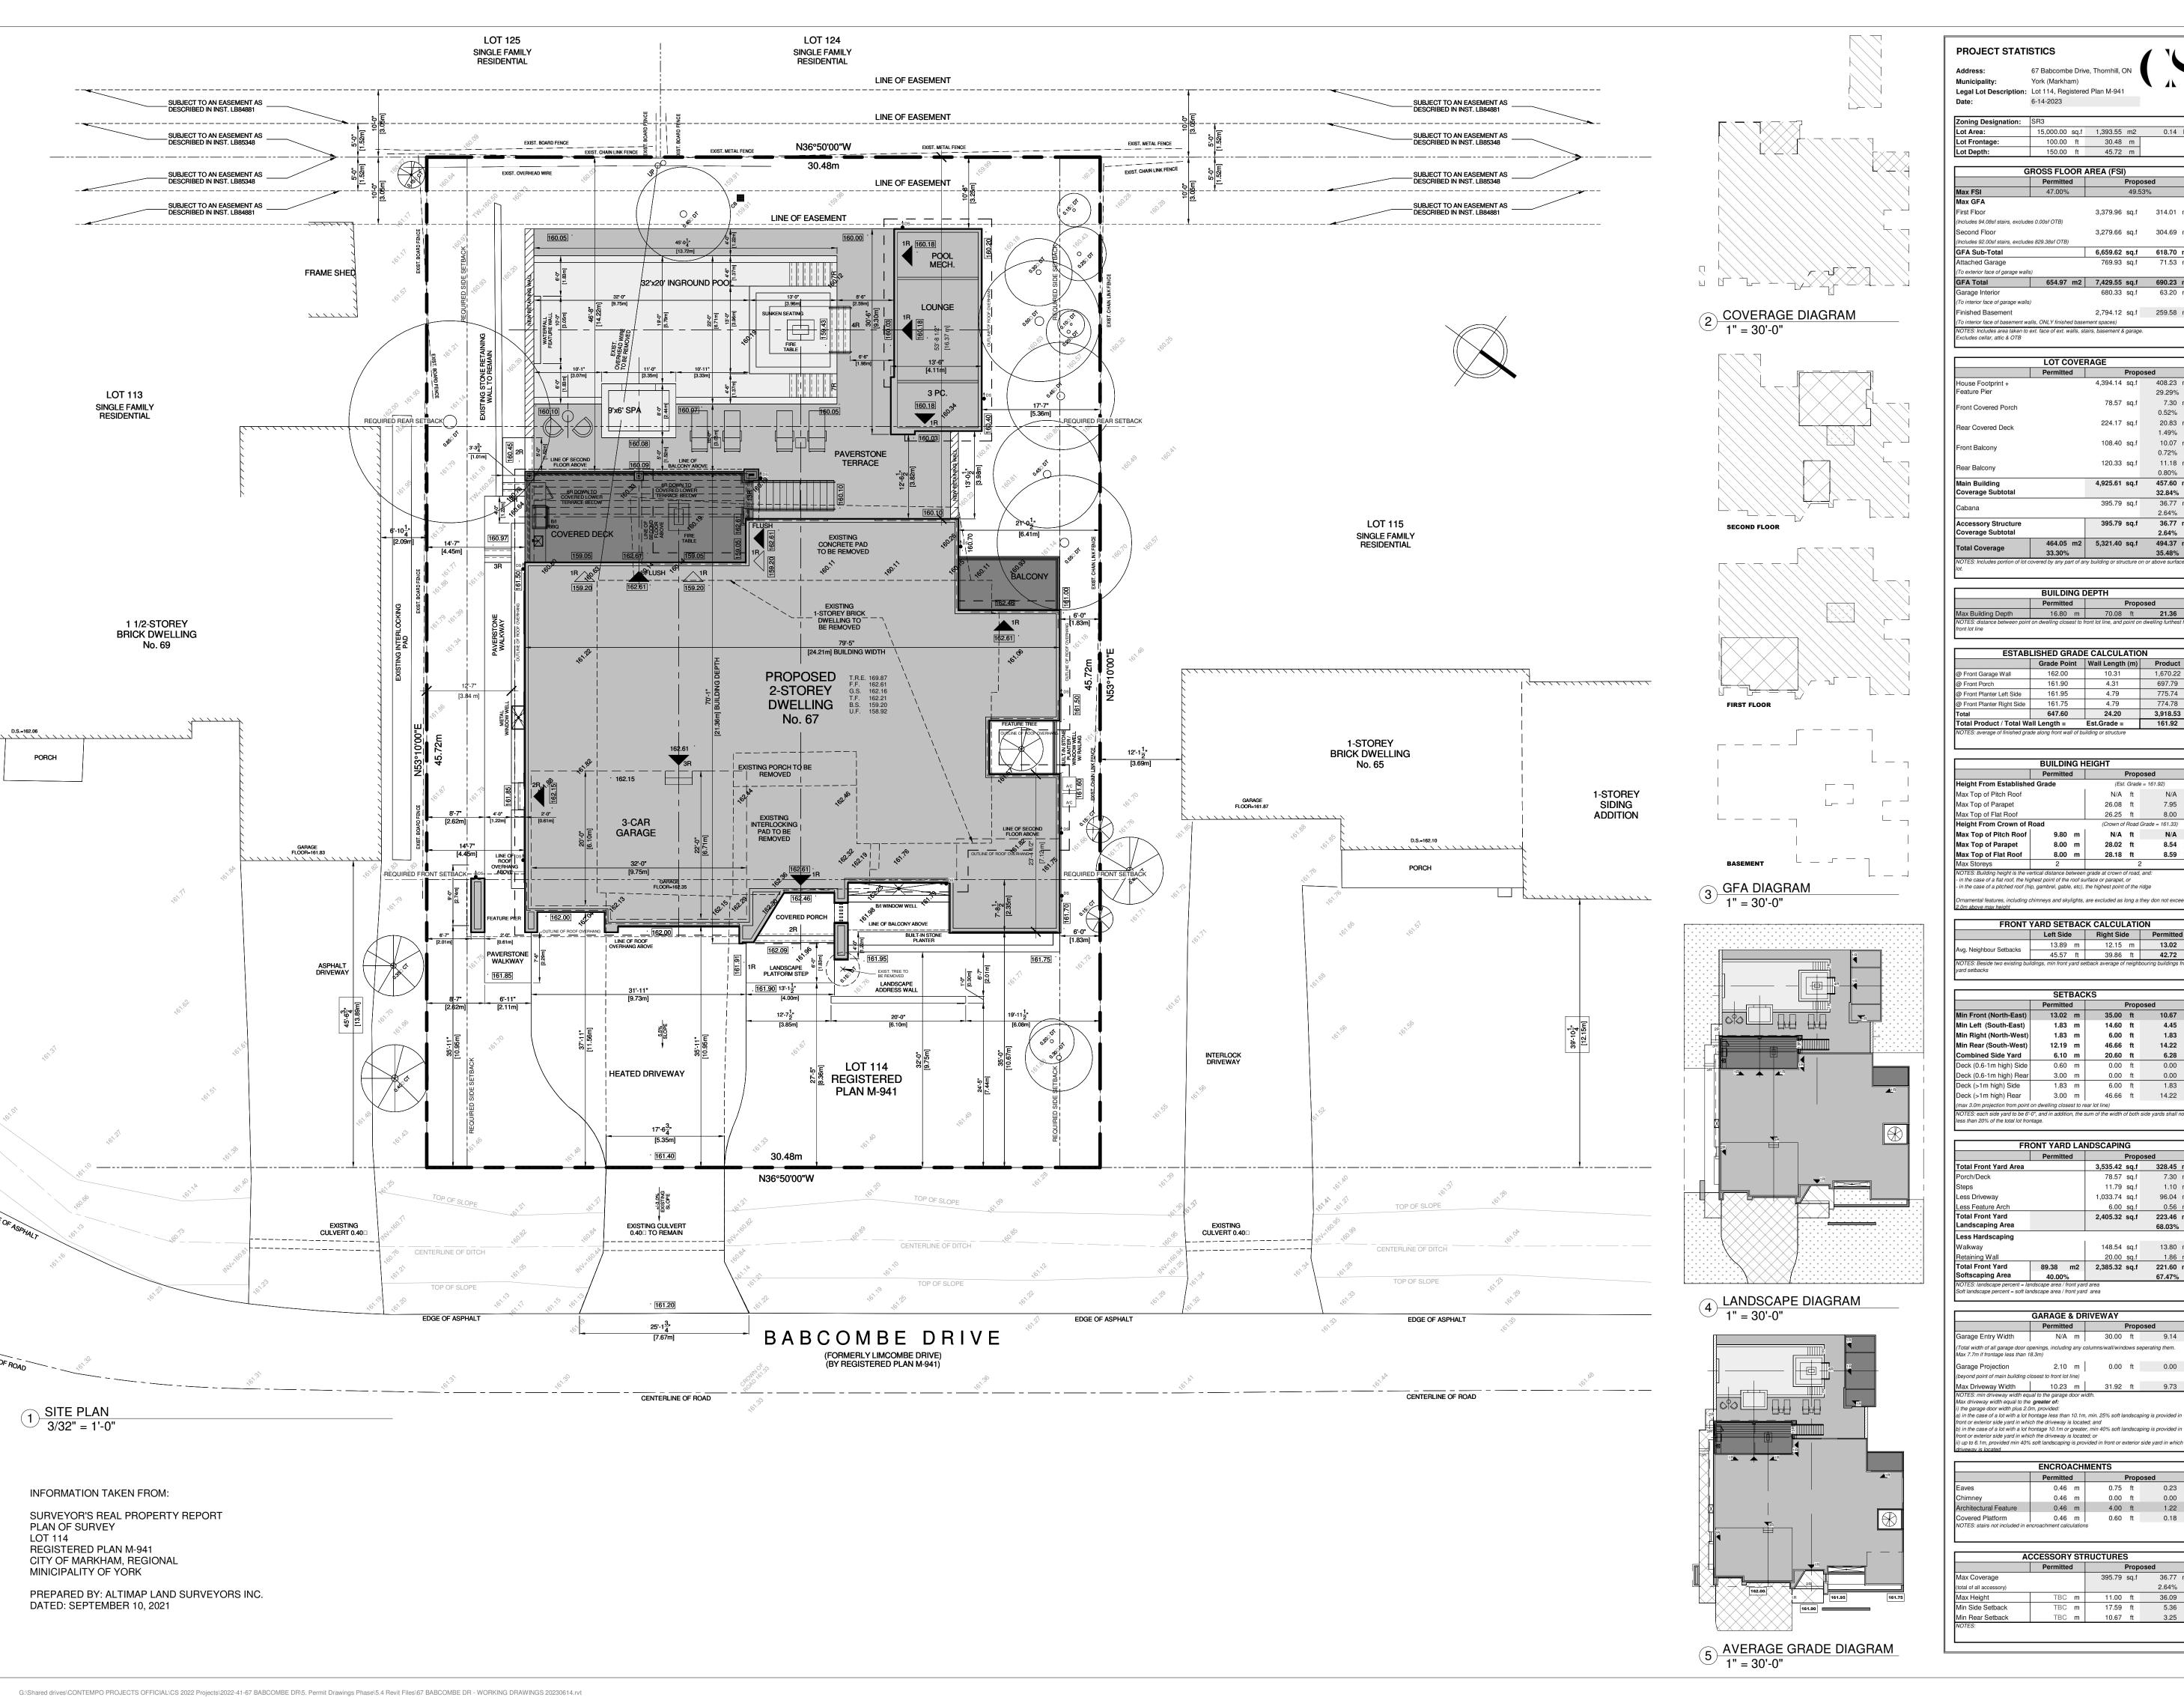

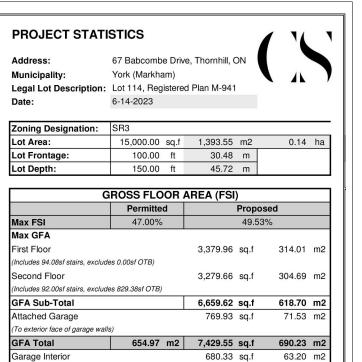2,794.12 sq.f 259.58 m2

	LOTOOVE	DAOE			
	LOT COVE	RAGE			
	Permitted		Prop	osed	
House Footprint +		4,394.14	sq.f	408.23	m2
Feature Pier				29.29%	
Control Daniel		78.57	sq.f	7.30	m2
Front Covered Porch				0.52%	
D O O O O O O O O O O O O O O O O O O O		224.17	sq.f	20.83	m2
Rear Covered Deck				1.49%	
Delegani		108.40	sq.f	10.07	m2
Front Balcony				0.72%	
D Delease.		120.33	sq.f	11.18	m2
Rear Balcony				0.80%	
Main Building		4,925.61	sq.f	457.60	m2
Coverage Subtotal				32.84%	
Cahana		395.79	sq.f	36.77	m2
Cabana				2.64%	
Accessory Structure		395.79	sq.f	36.77	m2
Coverage Subtotal				2.64%	
Total Coverage	464.05 m2	5,321.40	sq.f	494.37	m2
Total Coverage	33.30%			35.48%	

	BUILDING D	DEPTH		
	Permitted	Proposed		
ax Building Depth	16.80 m	70.08 ft	21.36	ı
OTES: distance between point ont lot line	on dwelling closest to f	ront lot line, and point on dwelli	ing furthes	t fi

	Grade Point	Wall Length (m)	Product	
@ Front Garage Wall	162.00	10.31	1,670.22	
@ Front Porch	161.90	4.31	697.79	
@ Front Planter Left Side	161.95	4.79	775.74	
@ Front Planter Right Side	161.75	4.79	774.78	
Total	647.60	24.20	3,918.53	
Total Product / Total Wa	all Length =	Est.Grade =	161.92	

	BUILDIN	IG H	IEIGHT			
	Permitted	t		Prop	osed	
Height From Establishe	d Grade		(Est	. Grad	e = 161.92)	
Max Top of Pitch Roof			N/A	ft	N/A	m
Max Top of Parapet			26.08	ft	7.95	m
Max Top of Flat Roof			26.25	ft	8.00	m
Height From Crown of F	Road		(Crown or	Road	Grade = 161.33)	
Max Top of Pitch Roof	9.80	m	N/A	ft	N/A	m
Max Top of Parapet	8.00	m	28.02	ft	8.54	m
Max Top of Flat Roof	8.00	m	28.18	ft	8.59	m
Max Storeys	2			- 1	2	
NOTES: Building height is the ve - in the case of a flat roof, the hig					l, and:	

	Left Side	Right Side	Permitte
Ava Najahbaur Cathaaka	13.89 m	12.15 m	13.02
Avg. Neighbour Setbacks	45.57 ft	39.86 ft	42.72

	SETBACKS								
	Permitte	Permitted			osed				
Min Front (North-East)	13.02	m	35.00	ft	10.67	m			
Min Left (South-East)	1.83	m	14.60	ft	4.45	m			
Min Right (North-West)	1.83	m	6.00	ft	1.83	m			
Min Rear (South-West)	12.19	m	46.66	ft	14.22	m			
Combined Side Yard	6.10	m	20.60	ft	6.28	m			
Deck (0.6-1m high) Side	0.60	m	0.00	ft	0.00	m			
Deck (0.6-1m high) Rear	3.00	m	0.00	ft	0.00	m			
Deck (>1m high) Side	1.83	m	6.00	ft	1.83	m			
Deck (>1m high) Rear	3.00	m	46.66	ft	14.22	m			
(max 3.0m projection from point of	on dwelling close	st to r	ear lot line)						
NOTES: each side yard to be 6'- less than 20% of the total lot fron		n, the s	sum of the width o	of both	side yards shall r	not be			

FRONT YARD LANDSCAPING							
Permitt	ted		Prop	osed			
		3,535.42	sq.f	328.45	m2		
		78.57	sq.f	7.30	m2		
		11.79	sq.f	1.10	m2		
		1,033.74	sq.f	96.04	m2		
		6.00	sq.f	0.56	m2		
		2,405.32	sq.f	223.46	m2		
				68.03%			
		148.54	sq.f	13.80	m2		
		20.00	sq.f	1.86	m2		
89.38	m2	2,385.32	sq.f	221.60	m2		
40.00	%			67.47%			
	Permitt	Permitted	Permitted   3,535.42   78.57   11.79   1,033.74   6.00   2,405.32   148.54   20.00   89.38   m2   2,385.32	Permitted         Prop           3,535.42 sq.f         78.57 sq.f           11.79 sq.f         11.79 sq.f           1,033.74 sq.f         6.00 sq.f           2,405.32 sq.f         148.54 sq.f           20.00 sq.f         2,385.32 sq.f	Permitted         Proposed           3,535.42         sq.f         328.45           78.57         sq.f         7.30           11.79         sq.f         1.10           1,033.74         sq.f         96.04           6.00         sq.f         0.56           2,405.32         sq.f         223.46           68.03%           148.54         sq.f         13.80           20.00         sq.f         1.86           89.38         m2         2,385.32         sq.f         221.60		

GARAGE & DRIVEWAY								
	Permitted	t		Prop	osed			
Garage Entry Width	N/A	m	30.00	ft	9.14	m		
(Total width of all garage door o Max 7.7m if frontage less than 1		any o	columns/wall/wind	ows s	seperating them.			
Garage Projection	2.10	m	0.00	ft	0.00	m		
(beyond point of main building c	losest to front lot	line)						
Max Driveway Width	10.23	m	31.92	ft	9.73	m		
NOTES: min driveway width equ Max driveway width equal to the ji the garage door width plus 2.0 a) in the case of a lot with a lot fi front or exterior side yard in while b) in the case of a lot with a lot fi front or exterior side yard in while ii) up to 6.1m, provided min 40%	greater of:  Im, provided:  rontage less than  ch the driveway is  rontage 10.1m or  ch the driveway is	10.1n locat greate locat	n, min. 25% soft la ed; and r, min 40% soft la ed; or	ndsca	aping is provided	in		

ENCROACHMENTS								
	Permitted	i		Prop	osed			
Eaves	0.46	m	0.75	ft	0.23	m		
Chimney	0.46	m	0.00	ft	0.00	m		
Architectural Feature	0.46	m	4.00	ft	1.22	m		
Covered Platform  NOTES: stairs not included in en	0.46 acroachment calc	m ulation	0.60	ft	0.18	m		

ACCESSORY STRUCTURES								
	Permitte	d		Prop	osed			
Coverage			395.79	sq.f	36.77	m2		
of all accessory)					2.64%			
Height	TBC	m	11.00	ft	36.09	m		
Side Setback	TBC	m	17.59	ft	5.36	m		
Rear Setback	TBC	m	10.67	ft	3.25	m		



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No.	Issued for:	Date
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2.		

### **contempo**studio

1140 The Queensway, Toronto, Ontario M8Z 1P7 info@contempostudio.ca w. contempostudio.ca t. (416) 770-0071 f. (416) 642-1691

The undersigned has reviewed and takes responsibility for this design, and has the qualifications and meets the requirements set out in the Ontario Building Code to design the work shown on the attached QUALIFICATION INFORMATION

Required unless design is exempt under 3.2.4.3.(5) Division C of the Ontario Building Code.

REGISTRATION INFORMATION Required unless design is exempt under 3.2.4.7. Division C of the Ontario Building Code. CONTEMPO STUDIO

2 STOREY DETACHED WELLING

ΑT 67 BABCOMBE DR THORNHILL, ON


SITE PLAN



2022-41 As indicated Scale: 2023-06-14 4:55:33 PM Drawn by: Approved by:

Drawing number:


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2 STOREY DETACHED WELLING

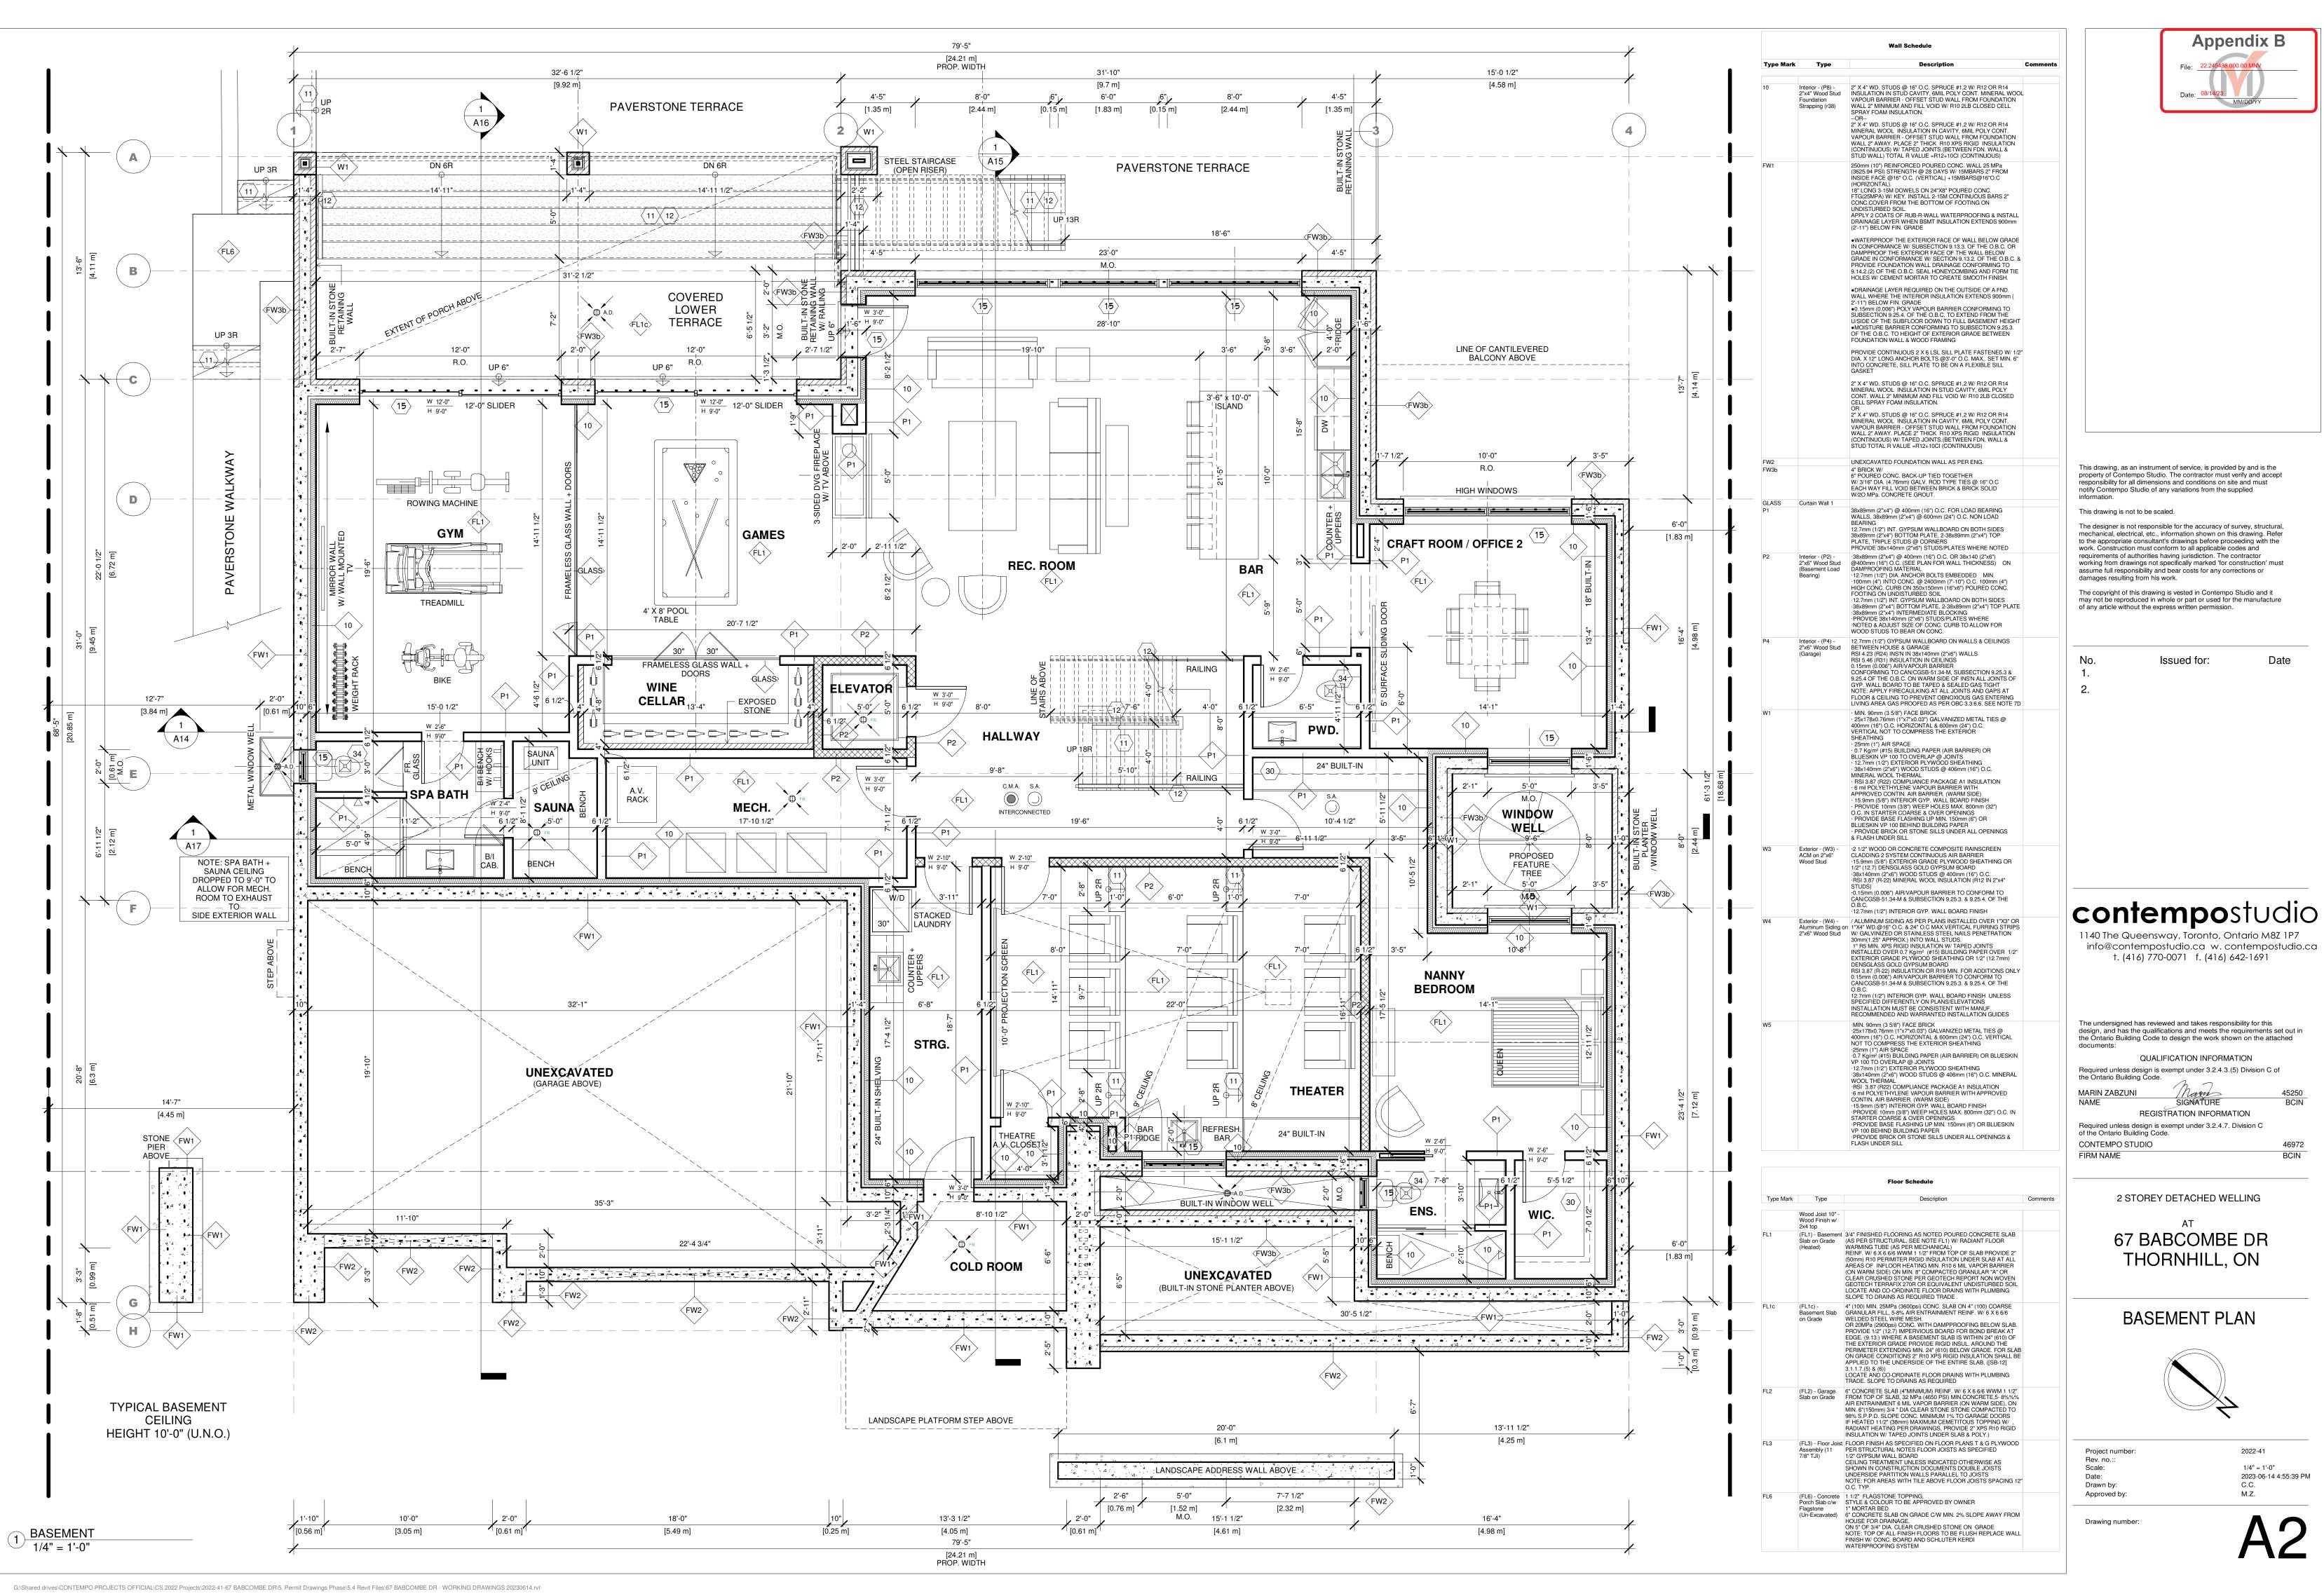
THORNHILL, ON

FIRST FLOOR PLAN



2022-41 1/4" = 1'-0" 2023-06-14 4:55:43 PM
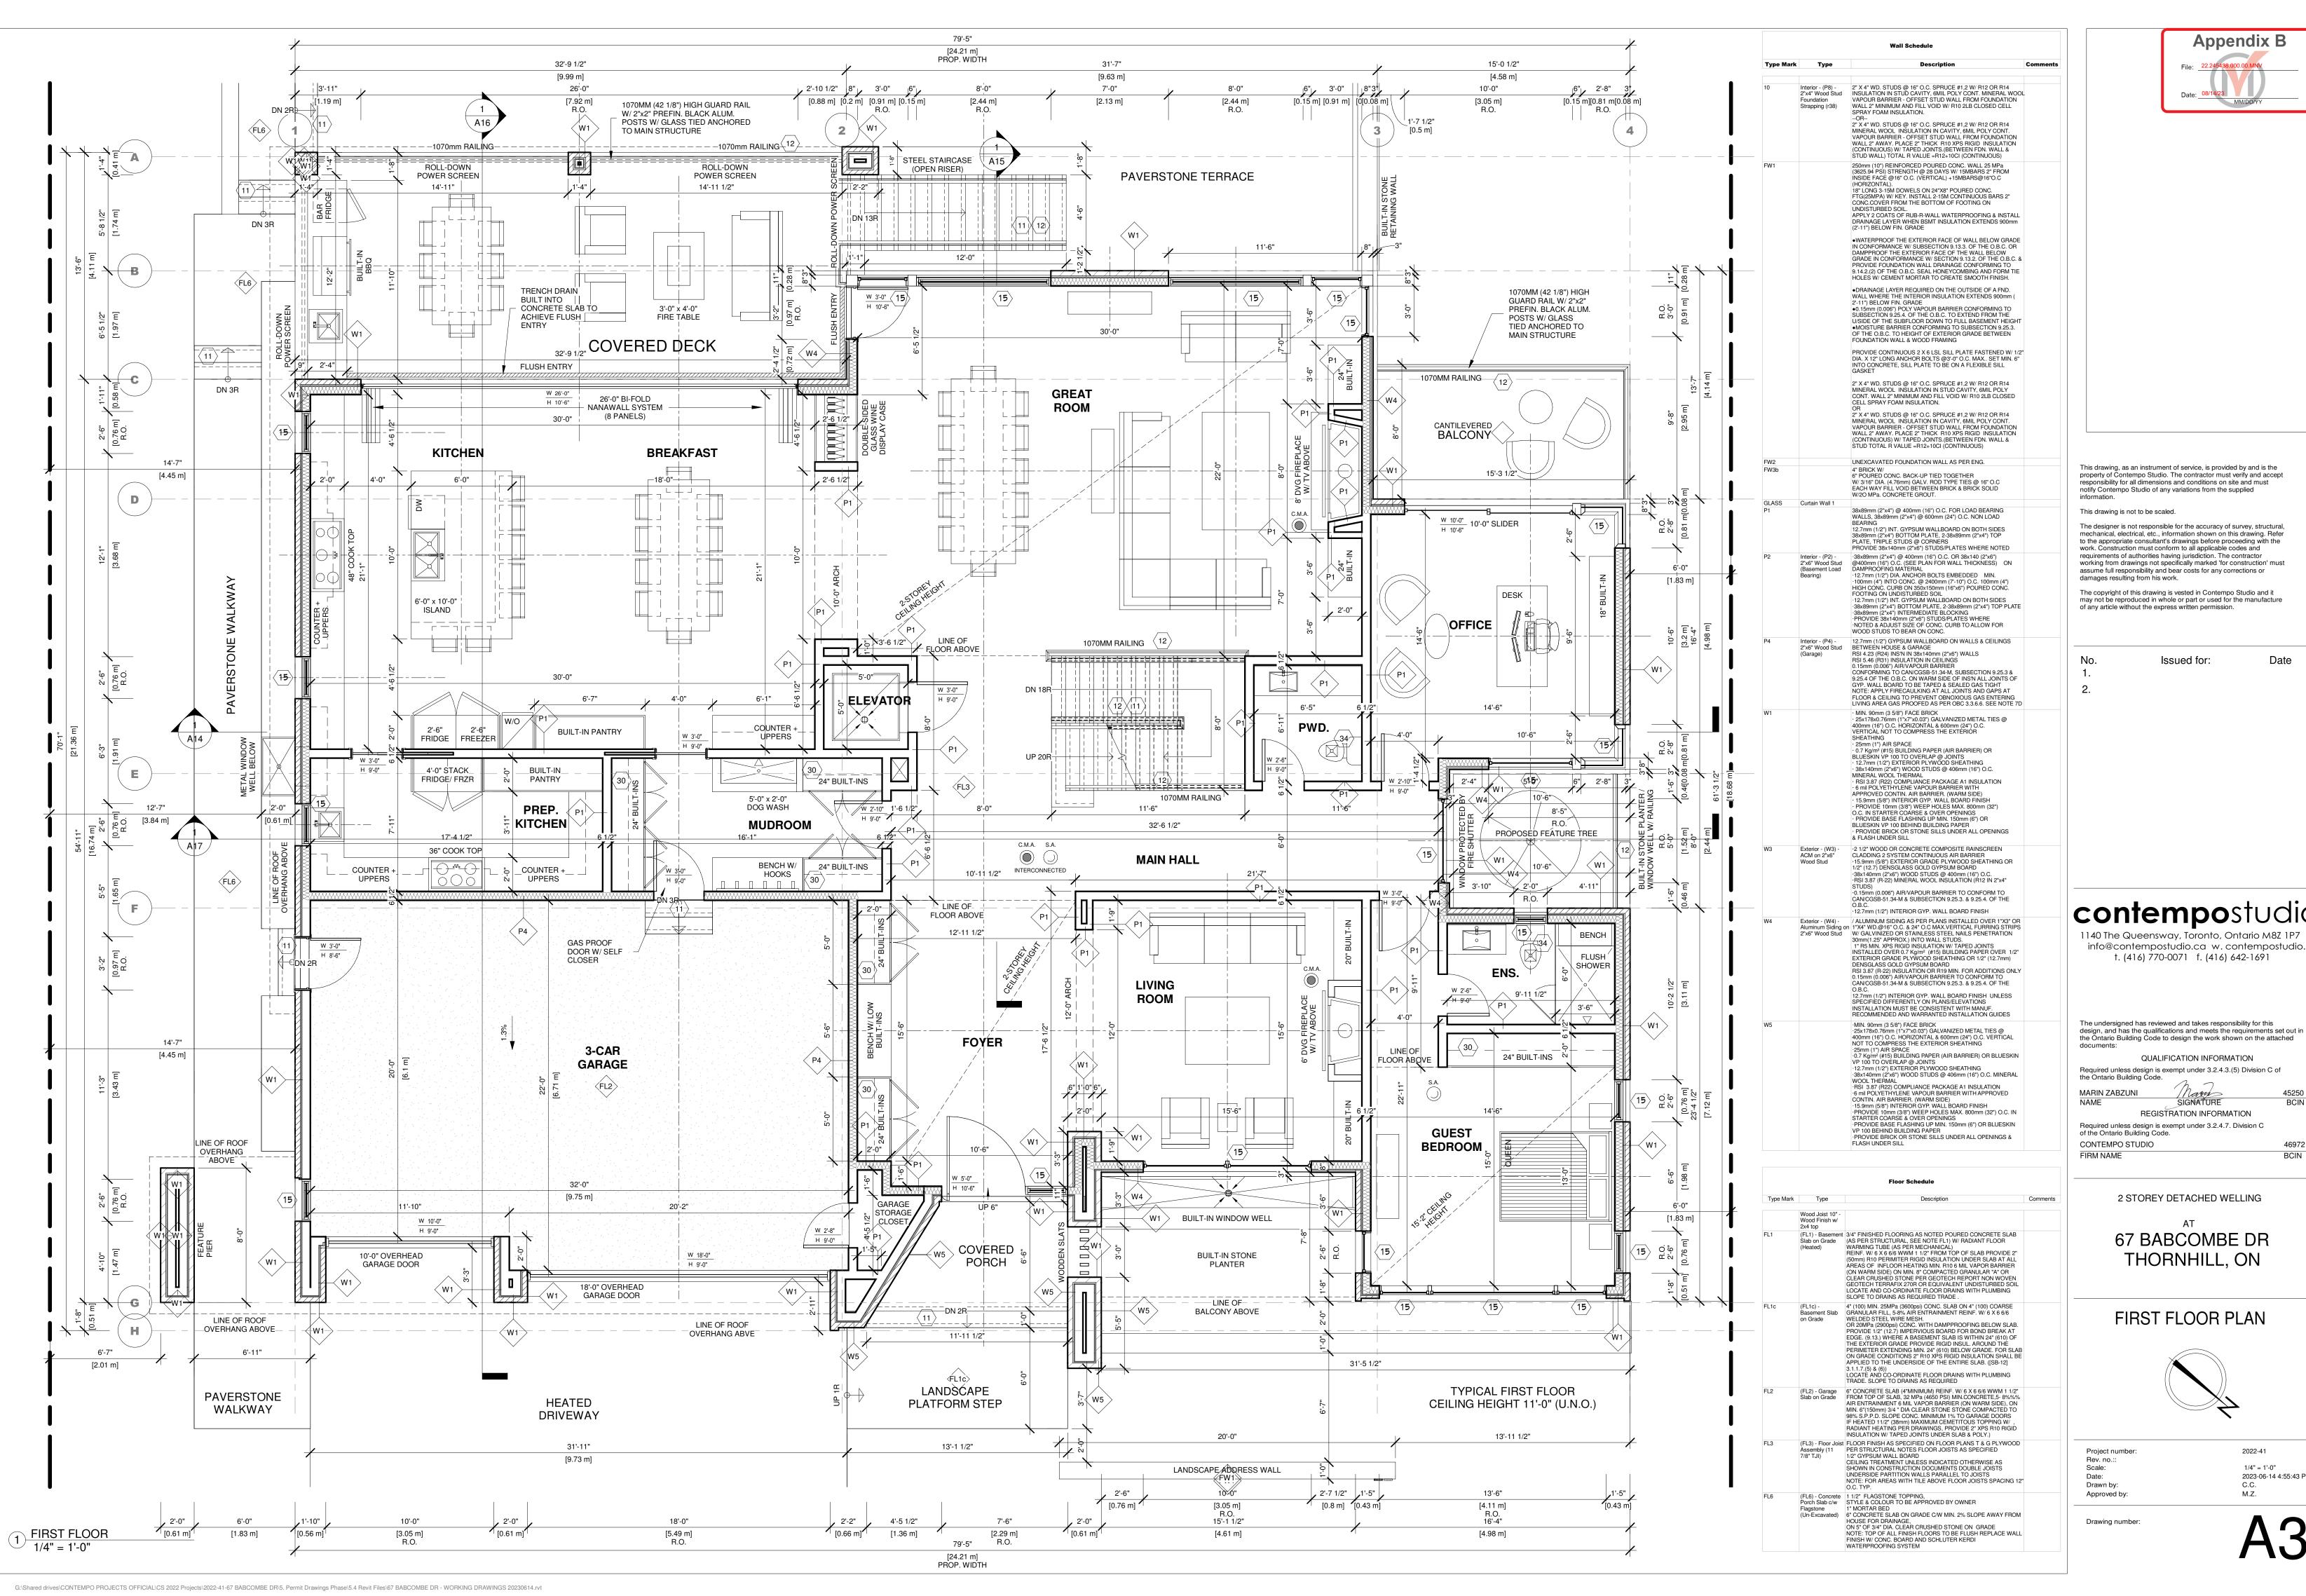
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2 STOREY DETACHED WELLING

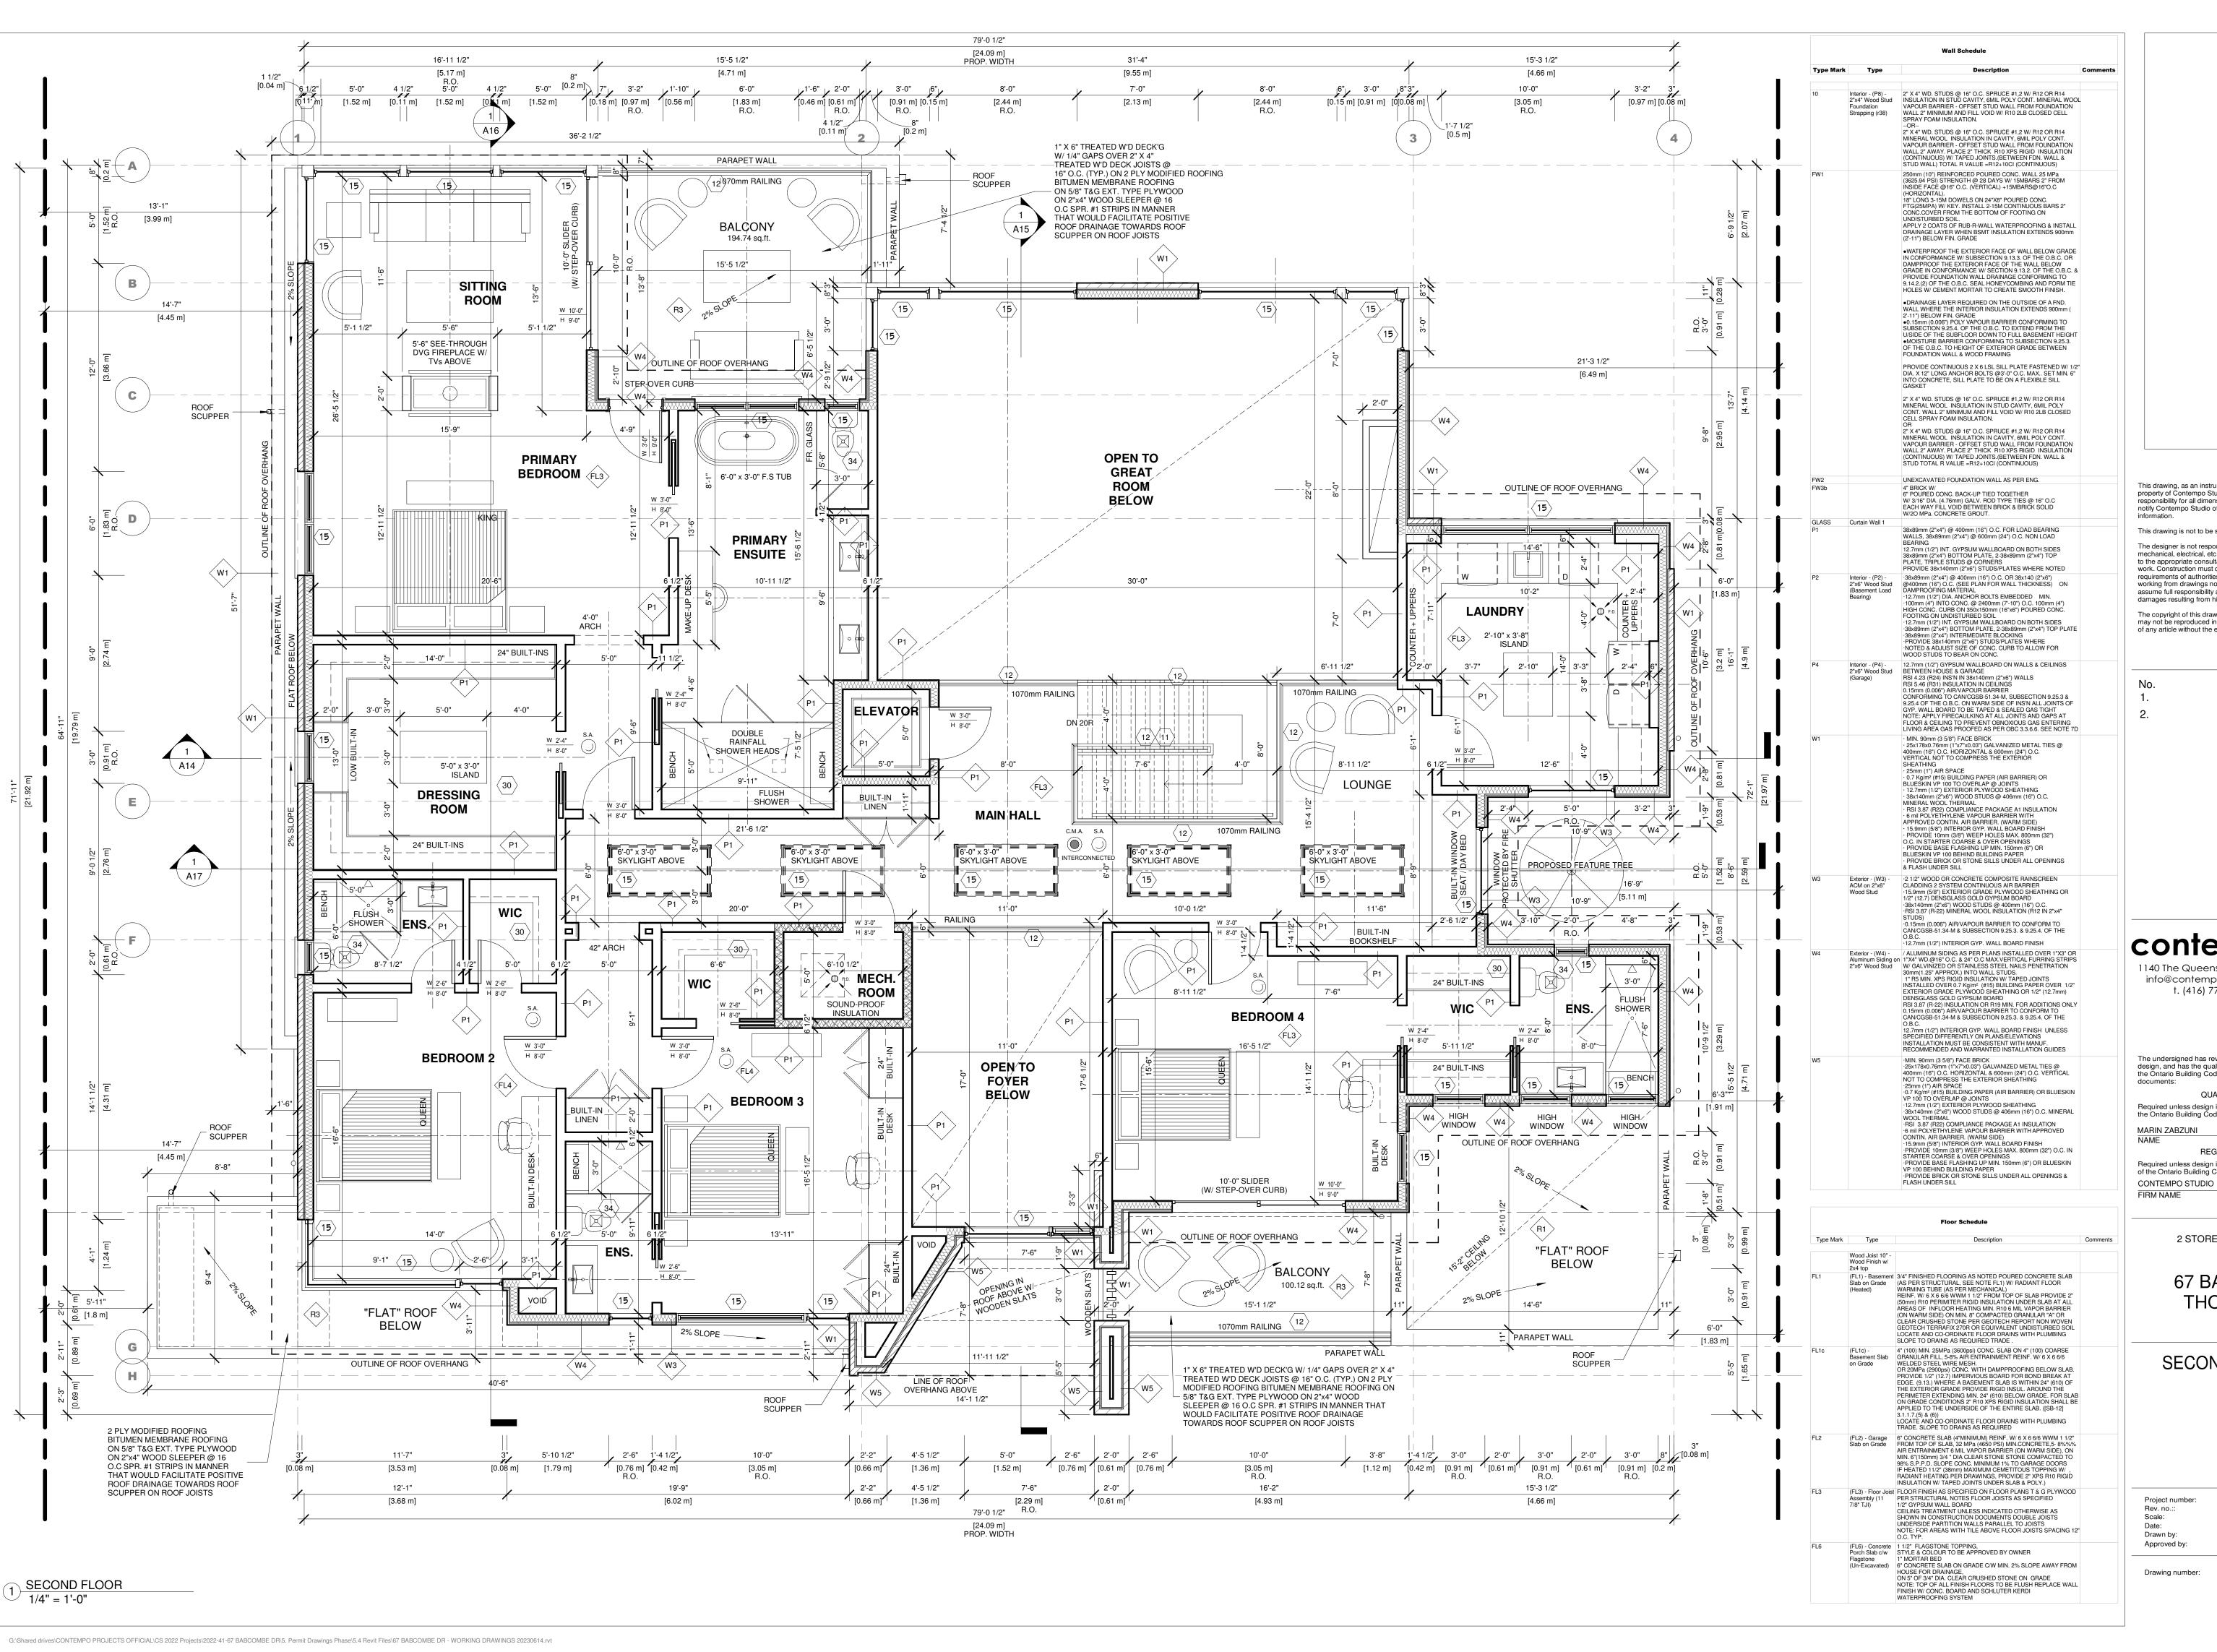ΑT 67 BABCOMBE DR THORNHILL, ON


SECOND FLOOR PLAN




Project number:

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Drawing number:



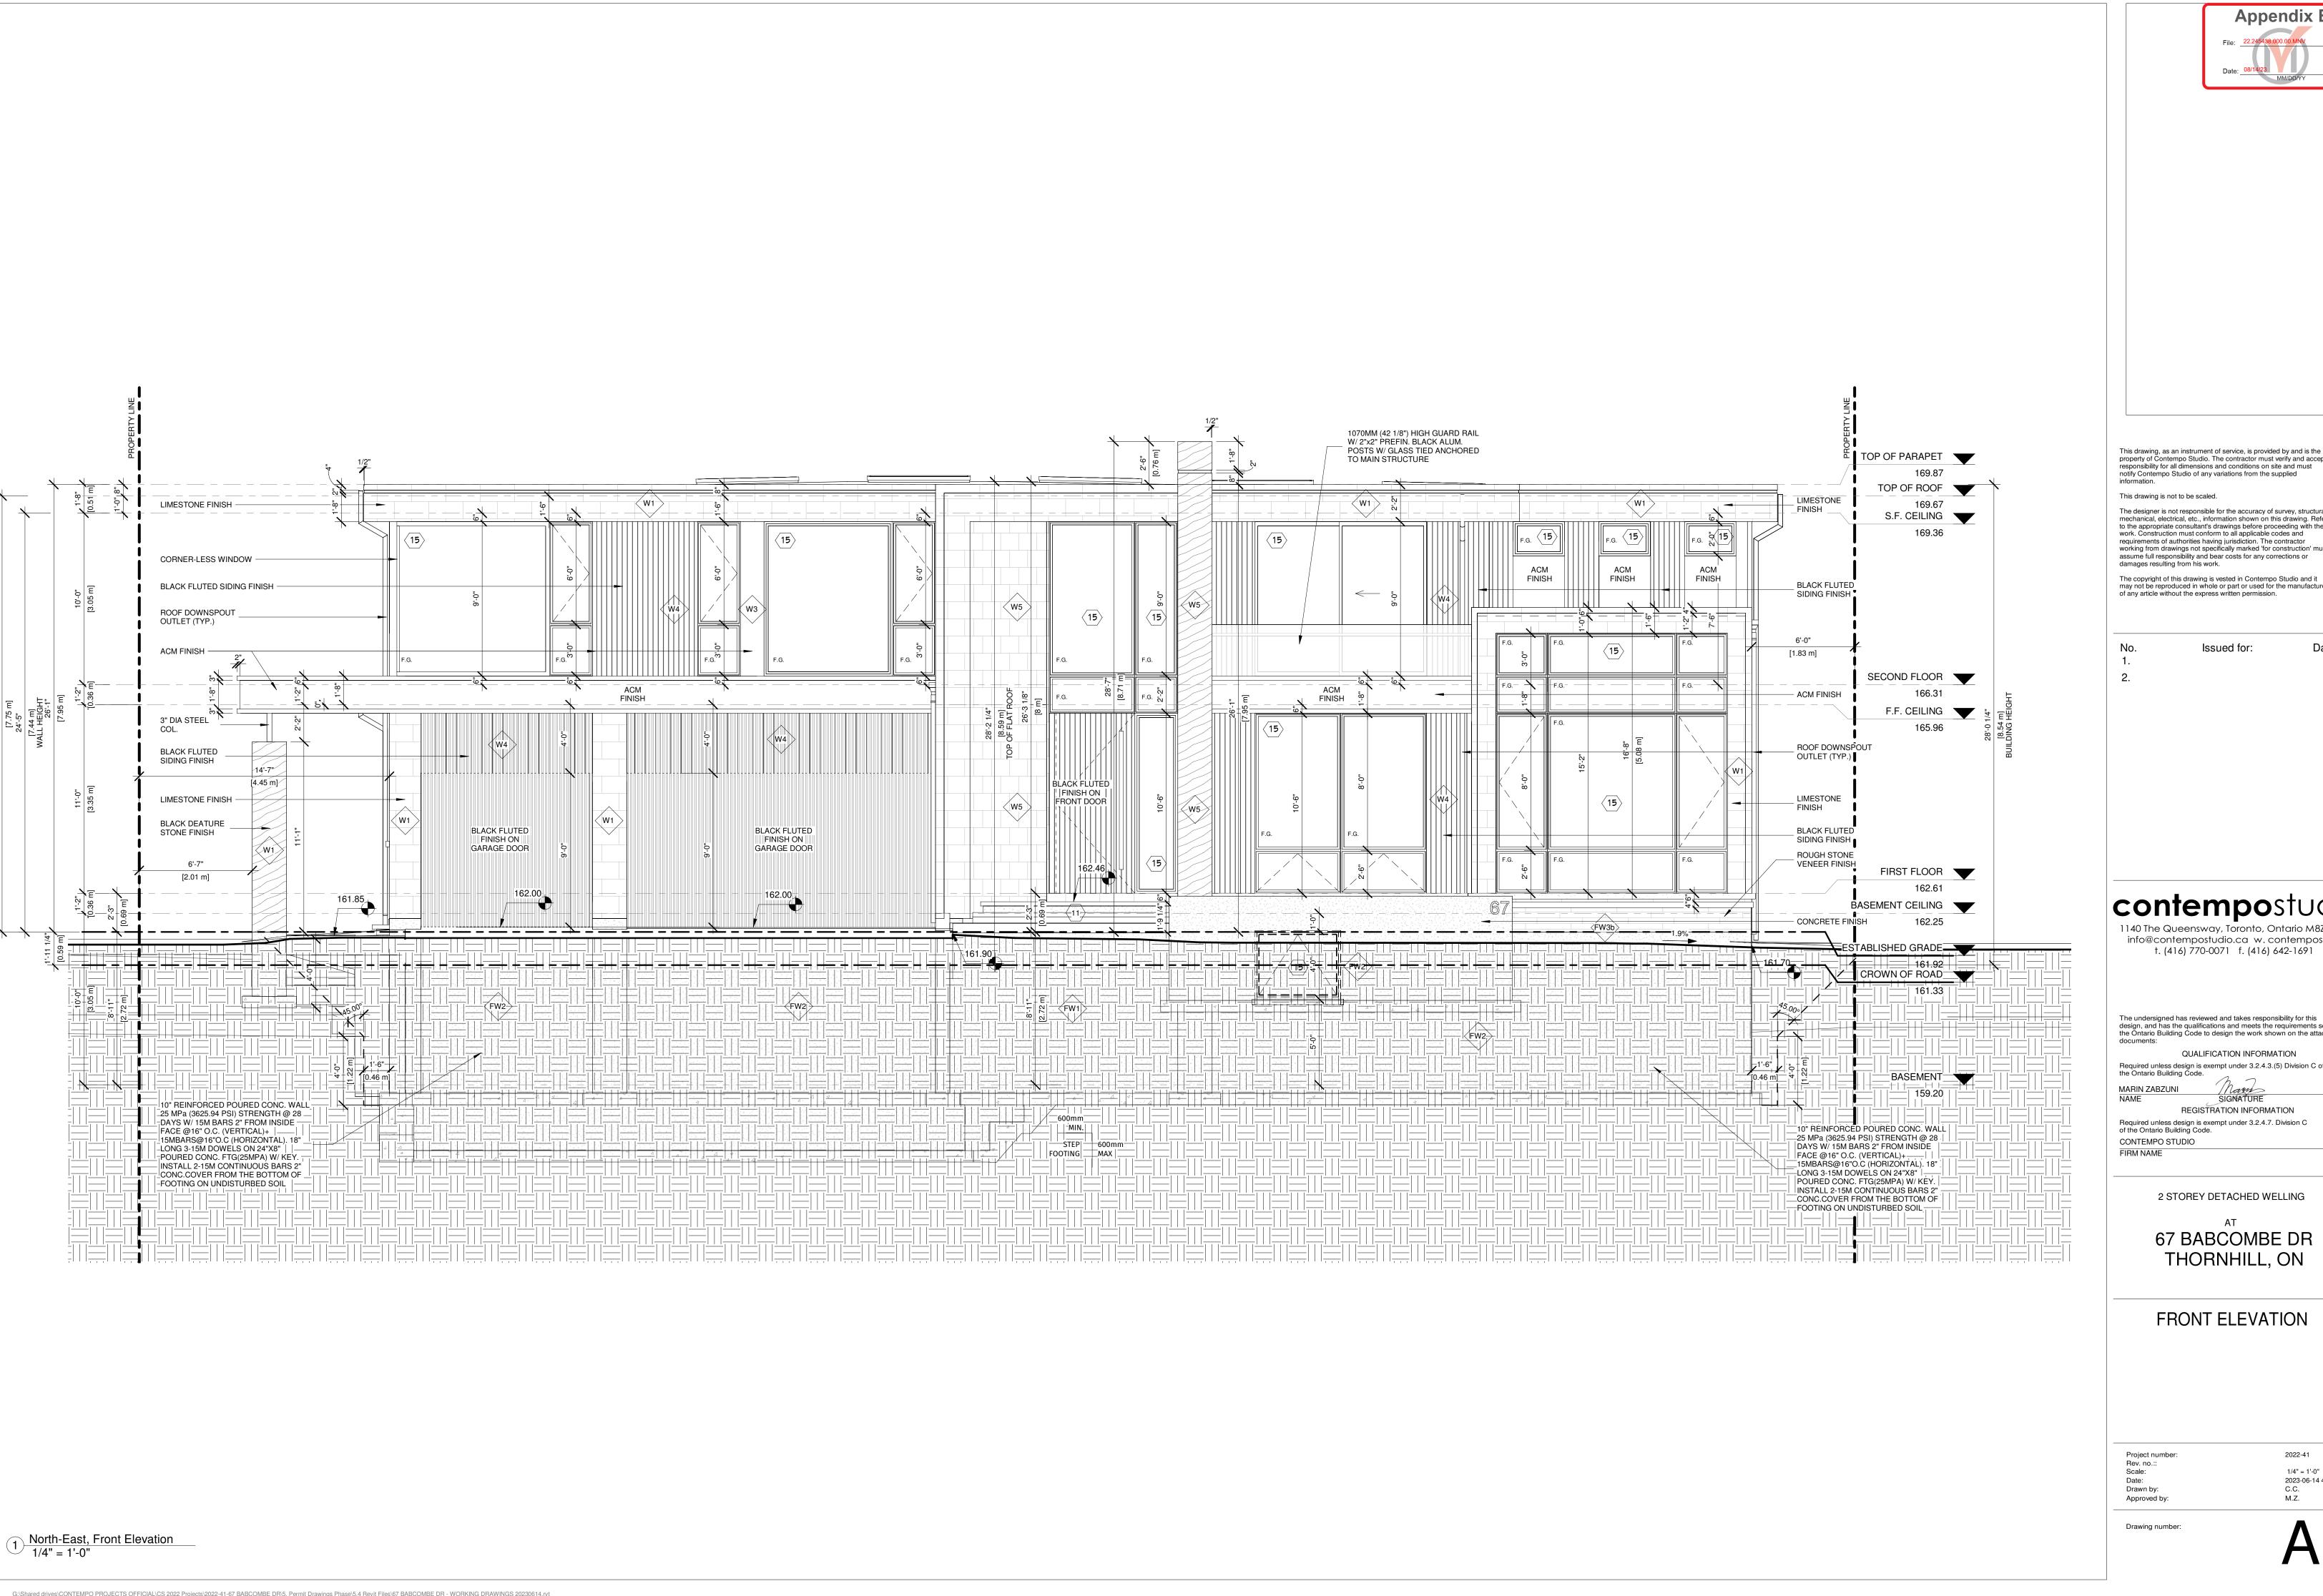
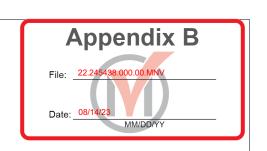
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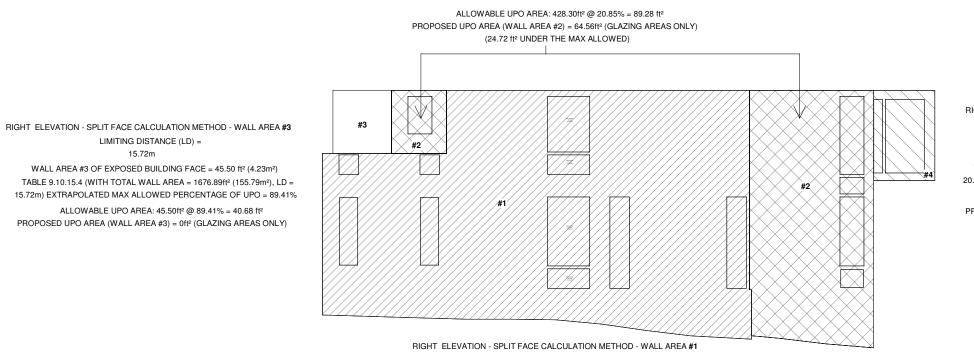
2 STOREY DETACHED WELLING

67 BABCOMBE DR THORNHILL, ON

ΑT

FRONT ELEVATION

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RIGHT ELEVATION - SPLIT FACE CALCULATION METHOD - WALL AREA #4 LIMITING DISTANCE (LD) =

20.75m

WALL AREA #4 OF EXPOSED BUILDING FACE = 67.92 ft² (6.31m²)

TABLE 9.10.15.4 (WITH TOTAL WALL AREA = 1676.89ft² (155.79m²), LD = 20.75m) EXTRAPOLATED MAX ALLOWED PERCENTAGE OF UPO = 100.00%

ALLOWABLE UPO AREA: 67.92ft² @ 100.00% = 67.92 ft²

PROPOSED UPO AREA (WALL AREA #4) = 43.22ft² (GLAZING AREAS ONLY)

(24.70 ft<sup>2</sup> UNDER THE MAX ALLOWED)

RIGHT ELEVATION UNPROTECTED

AREA CALCS.

3/32" = 1'-0"

1.83m

WALL AREA #1 OF EXPOSED BUILDING FACE = 1,135.17 ft² (105.46m²)


TABLE 9.10.15.4 (WITH TOTAL WALL AREA = 1676.89ft² (155.79m²), LD = 1.83m) EXTRAPOLATED MAX ALLOWED PERCENTAGE OF UPO = 7.66%


LIMITING DISTANCE (LD) =

RIGHT ELEVATION - SPLIT FACE CALCULATION METHOD - WALL AREA #2
LIMITING DISTANCE (LD) =

WALL AREA #2 OF EXPOSED BUILDING FACE =  $428.30 \text{ ft}^2 (39.79\text{m}^2)$ TABLE 9.10.15.4 (WITH TOTAL WALL AREA =  $1676.89\text{ft}^2 (155.79\text{m}^2)$ , LD = 6.41m) EXTRAPOLATED MAX ALLOWED PERCENTAGE OF UPO = 20.85%

ALLOWABLE UPO AREA: 1,135.17ft² @ 7.66% = 86.95 ft²
PROPOSED UPO AREA (WALL AREA #1) = 85.00ft² (GLAZING AREAS ONLY)

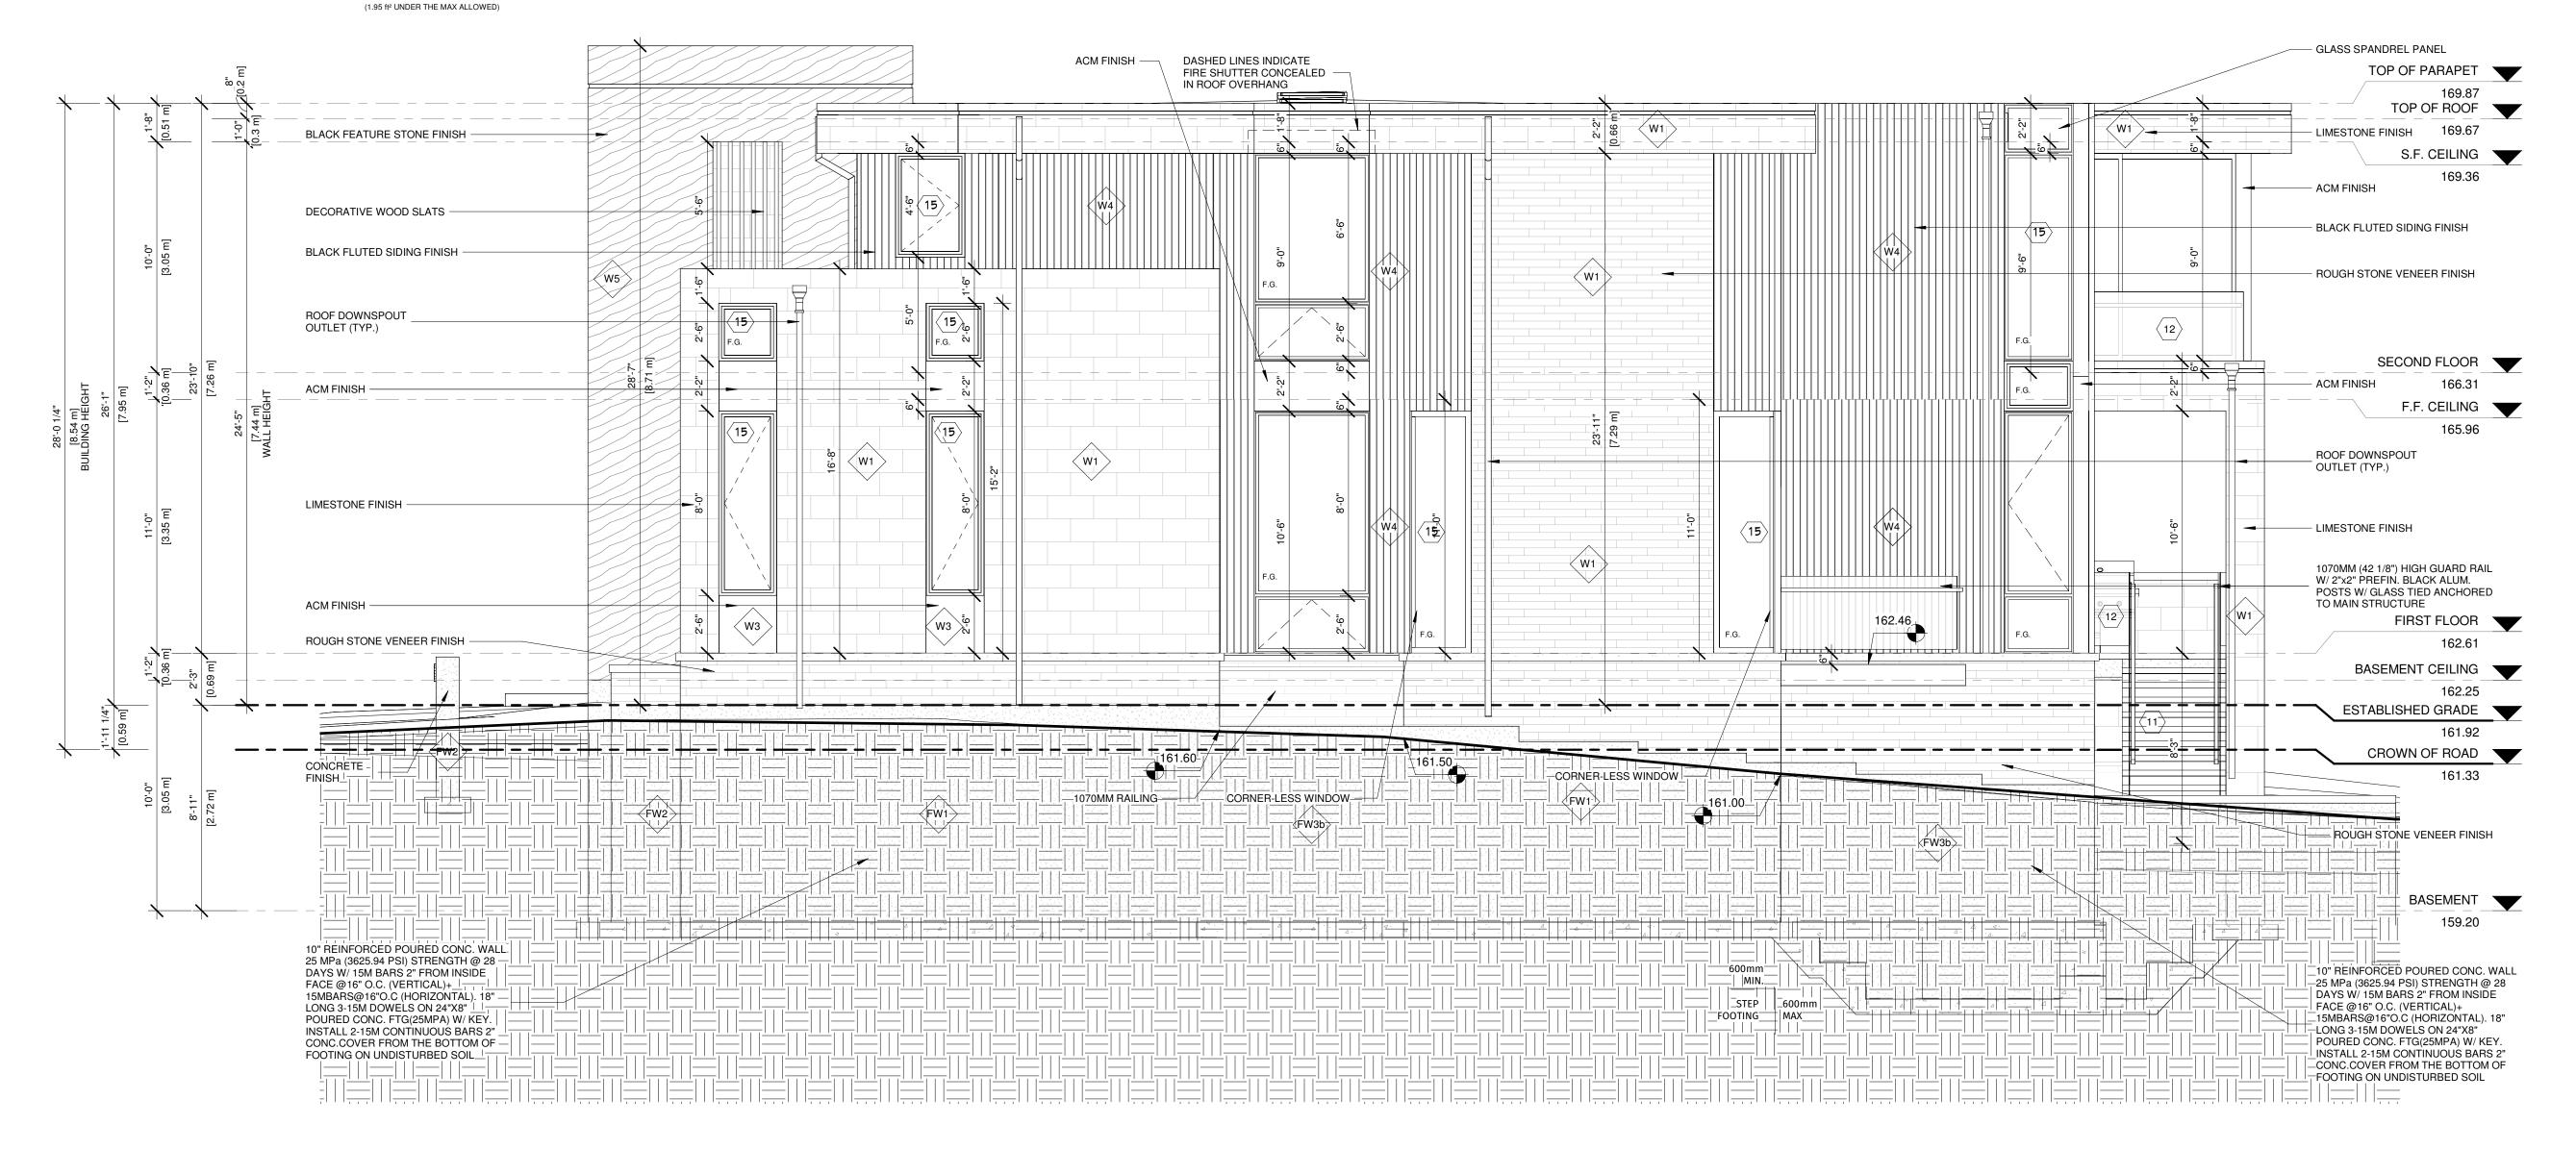

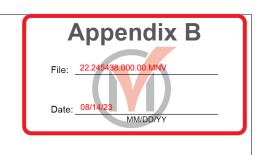

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The undersigned has reviewed and takes responsibility for this

MARIN ZABZUNI
NAME
SIGNATURE
REGISTRATION INFORMATION
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CONTEMPO STUDIO
FIRM NAME

2 STOREY DETACHED WELLING

67 BABCOMBE DR THORNHILL, ON

ΑT

RIGHT ELEVATION

Project number:
Rev. no.::
Scale:
Date:
Drawn by:
Approved by:


2022-41

As indicated
2023-06-14 4:55:49 PM
C.C.

Drawing number:

**A**7

46972

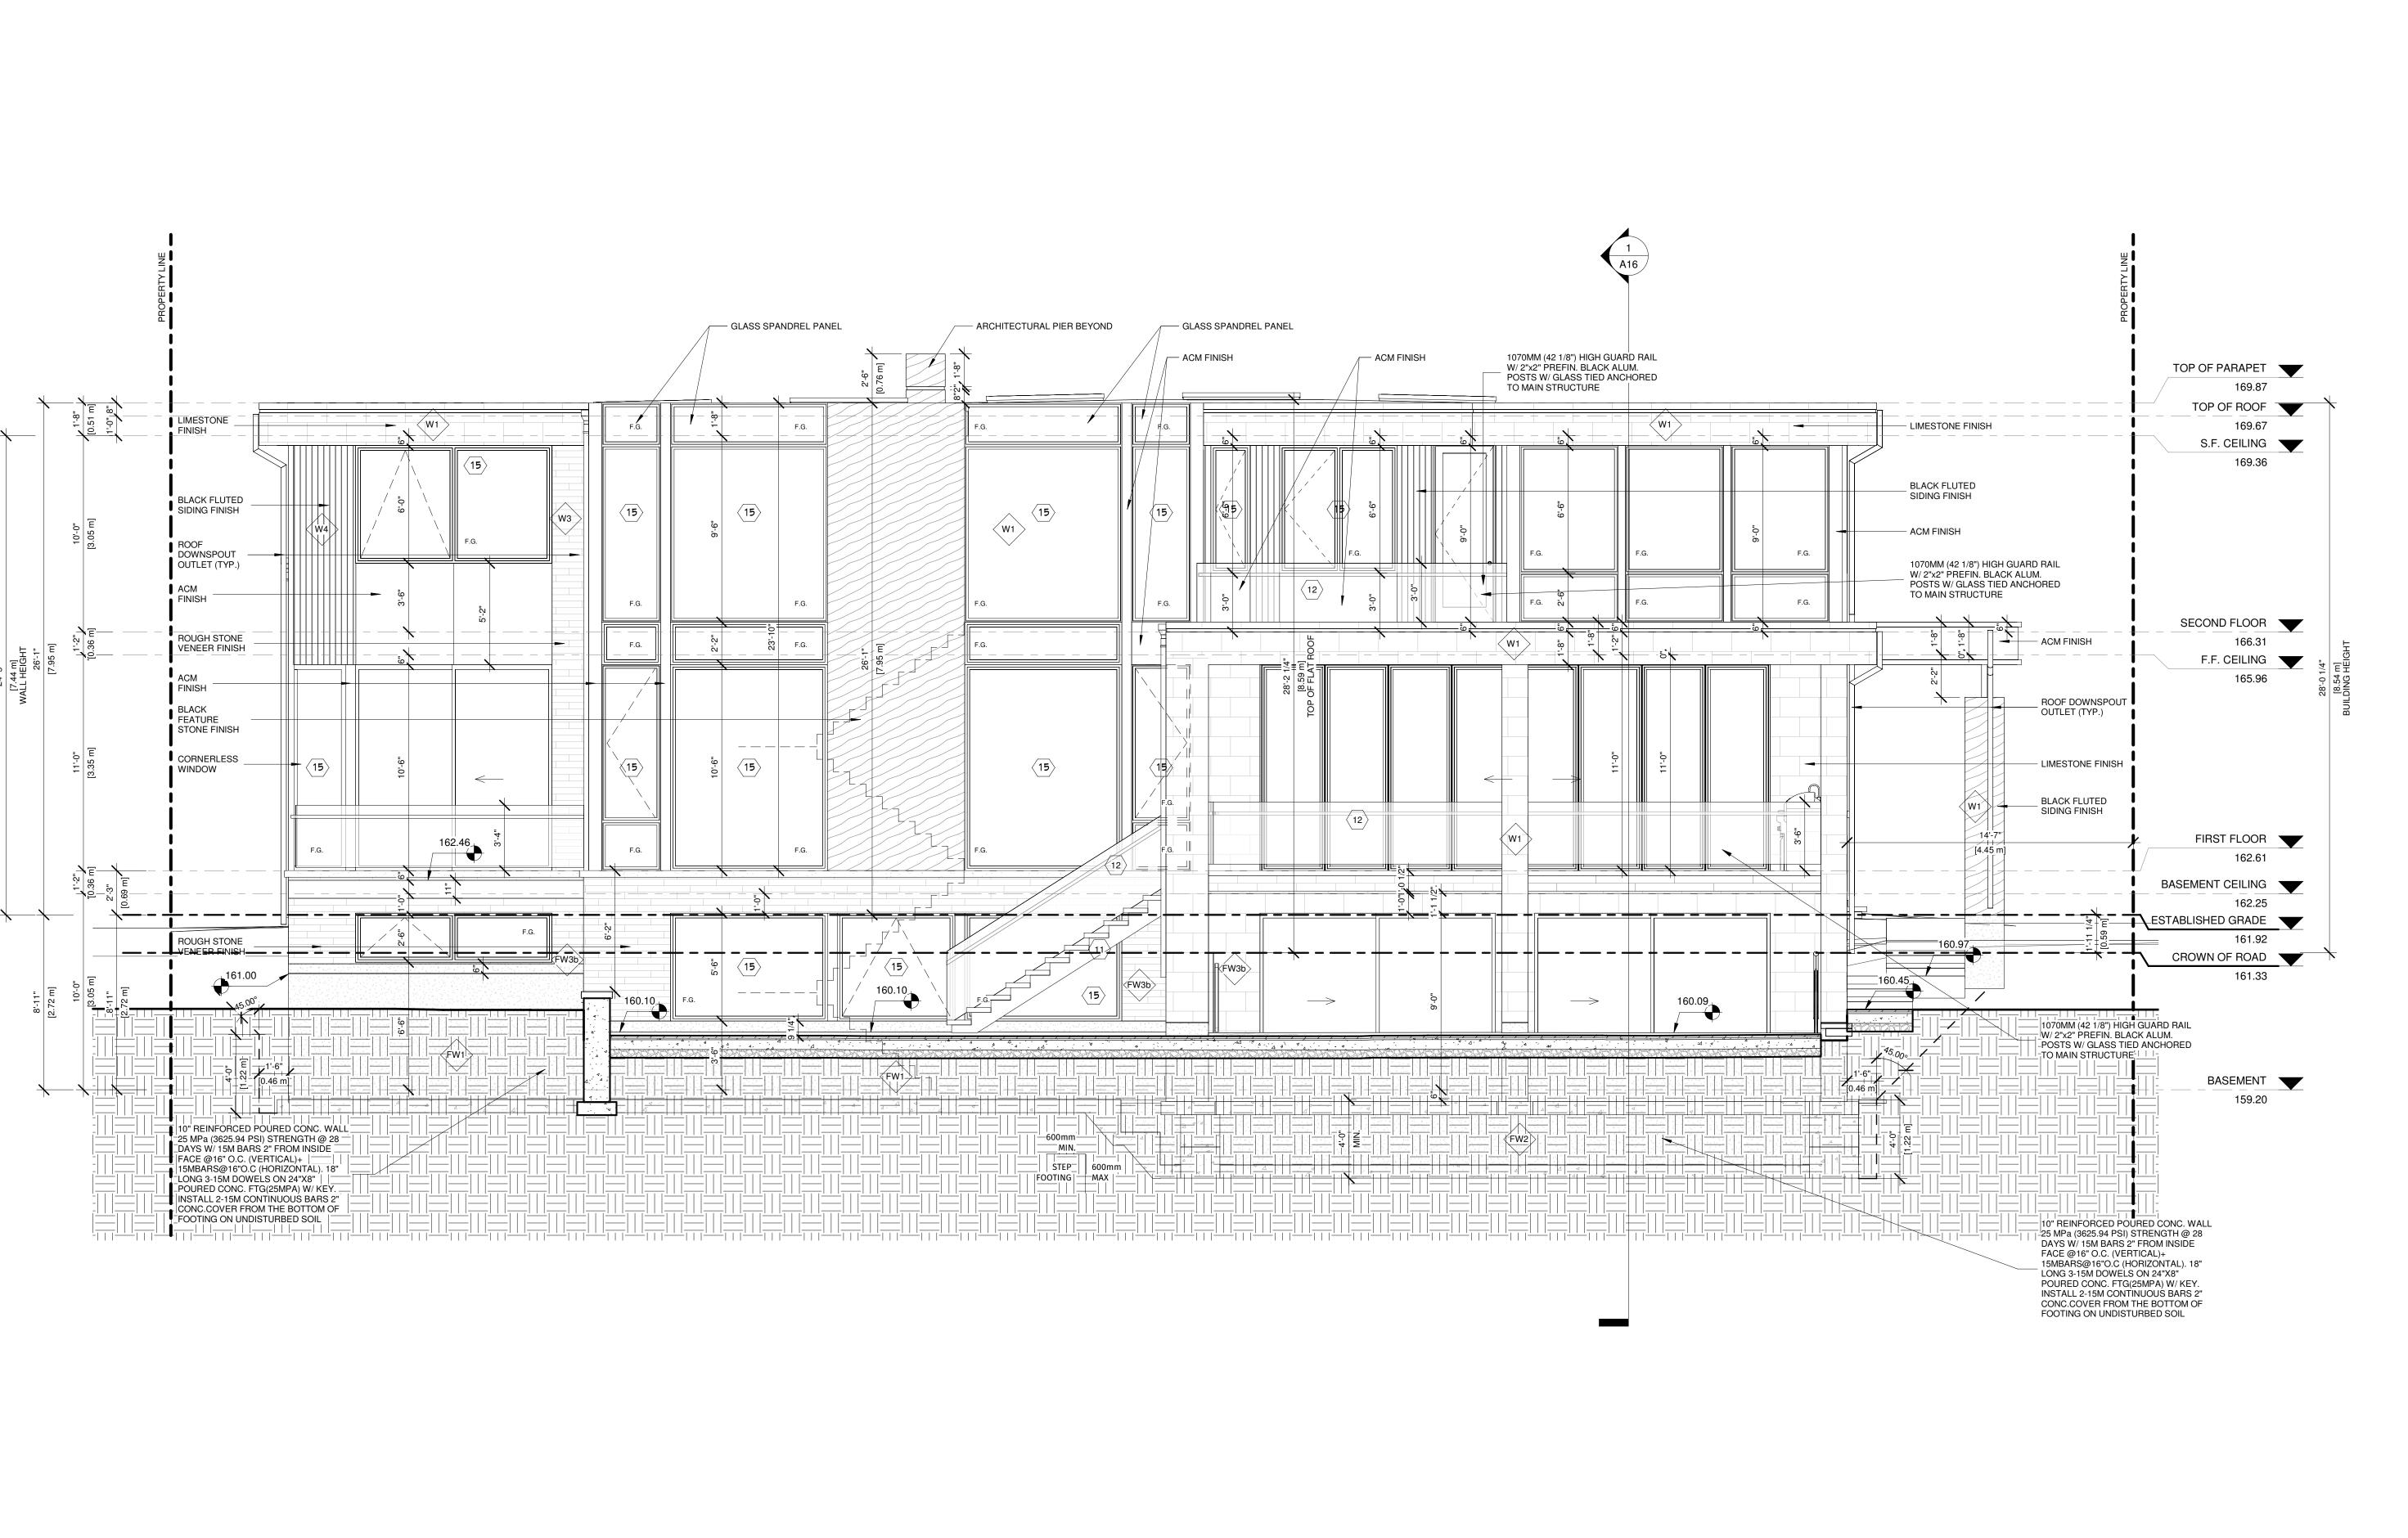



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CONTEMPO STUDIO
FIRM NAME

2 STOREY DETACHED WELLING

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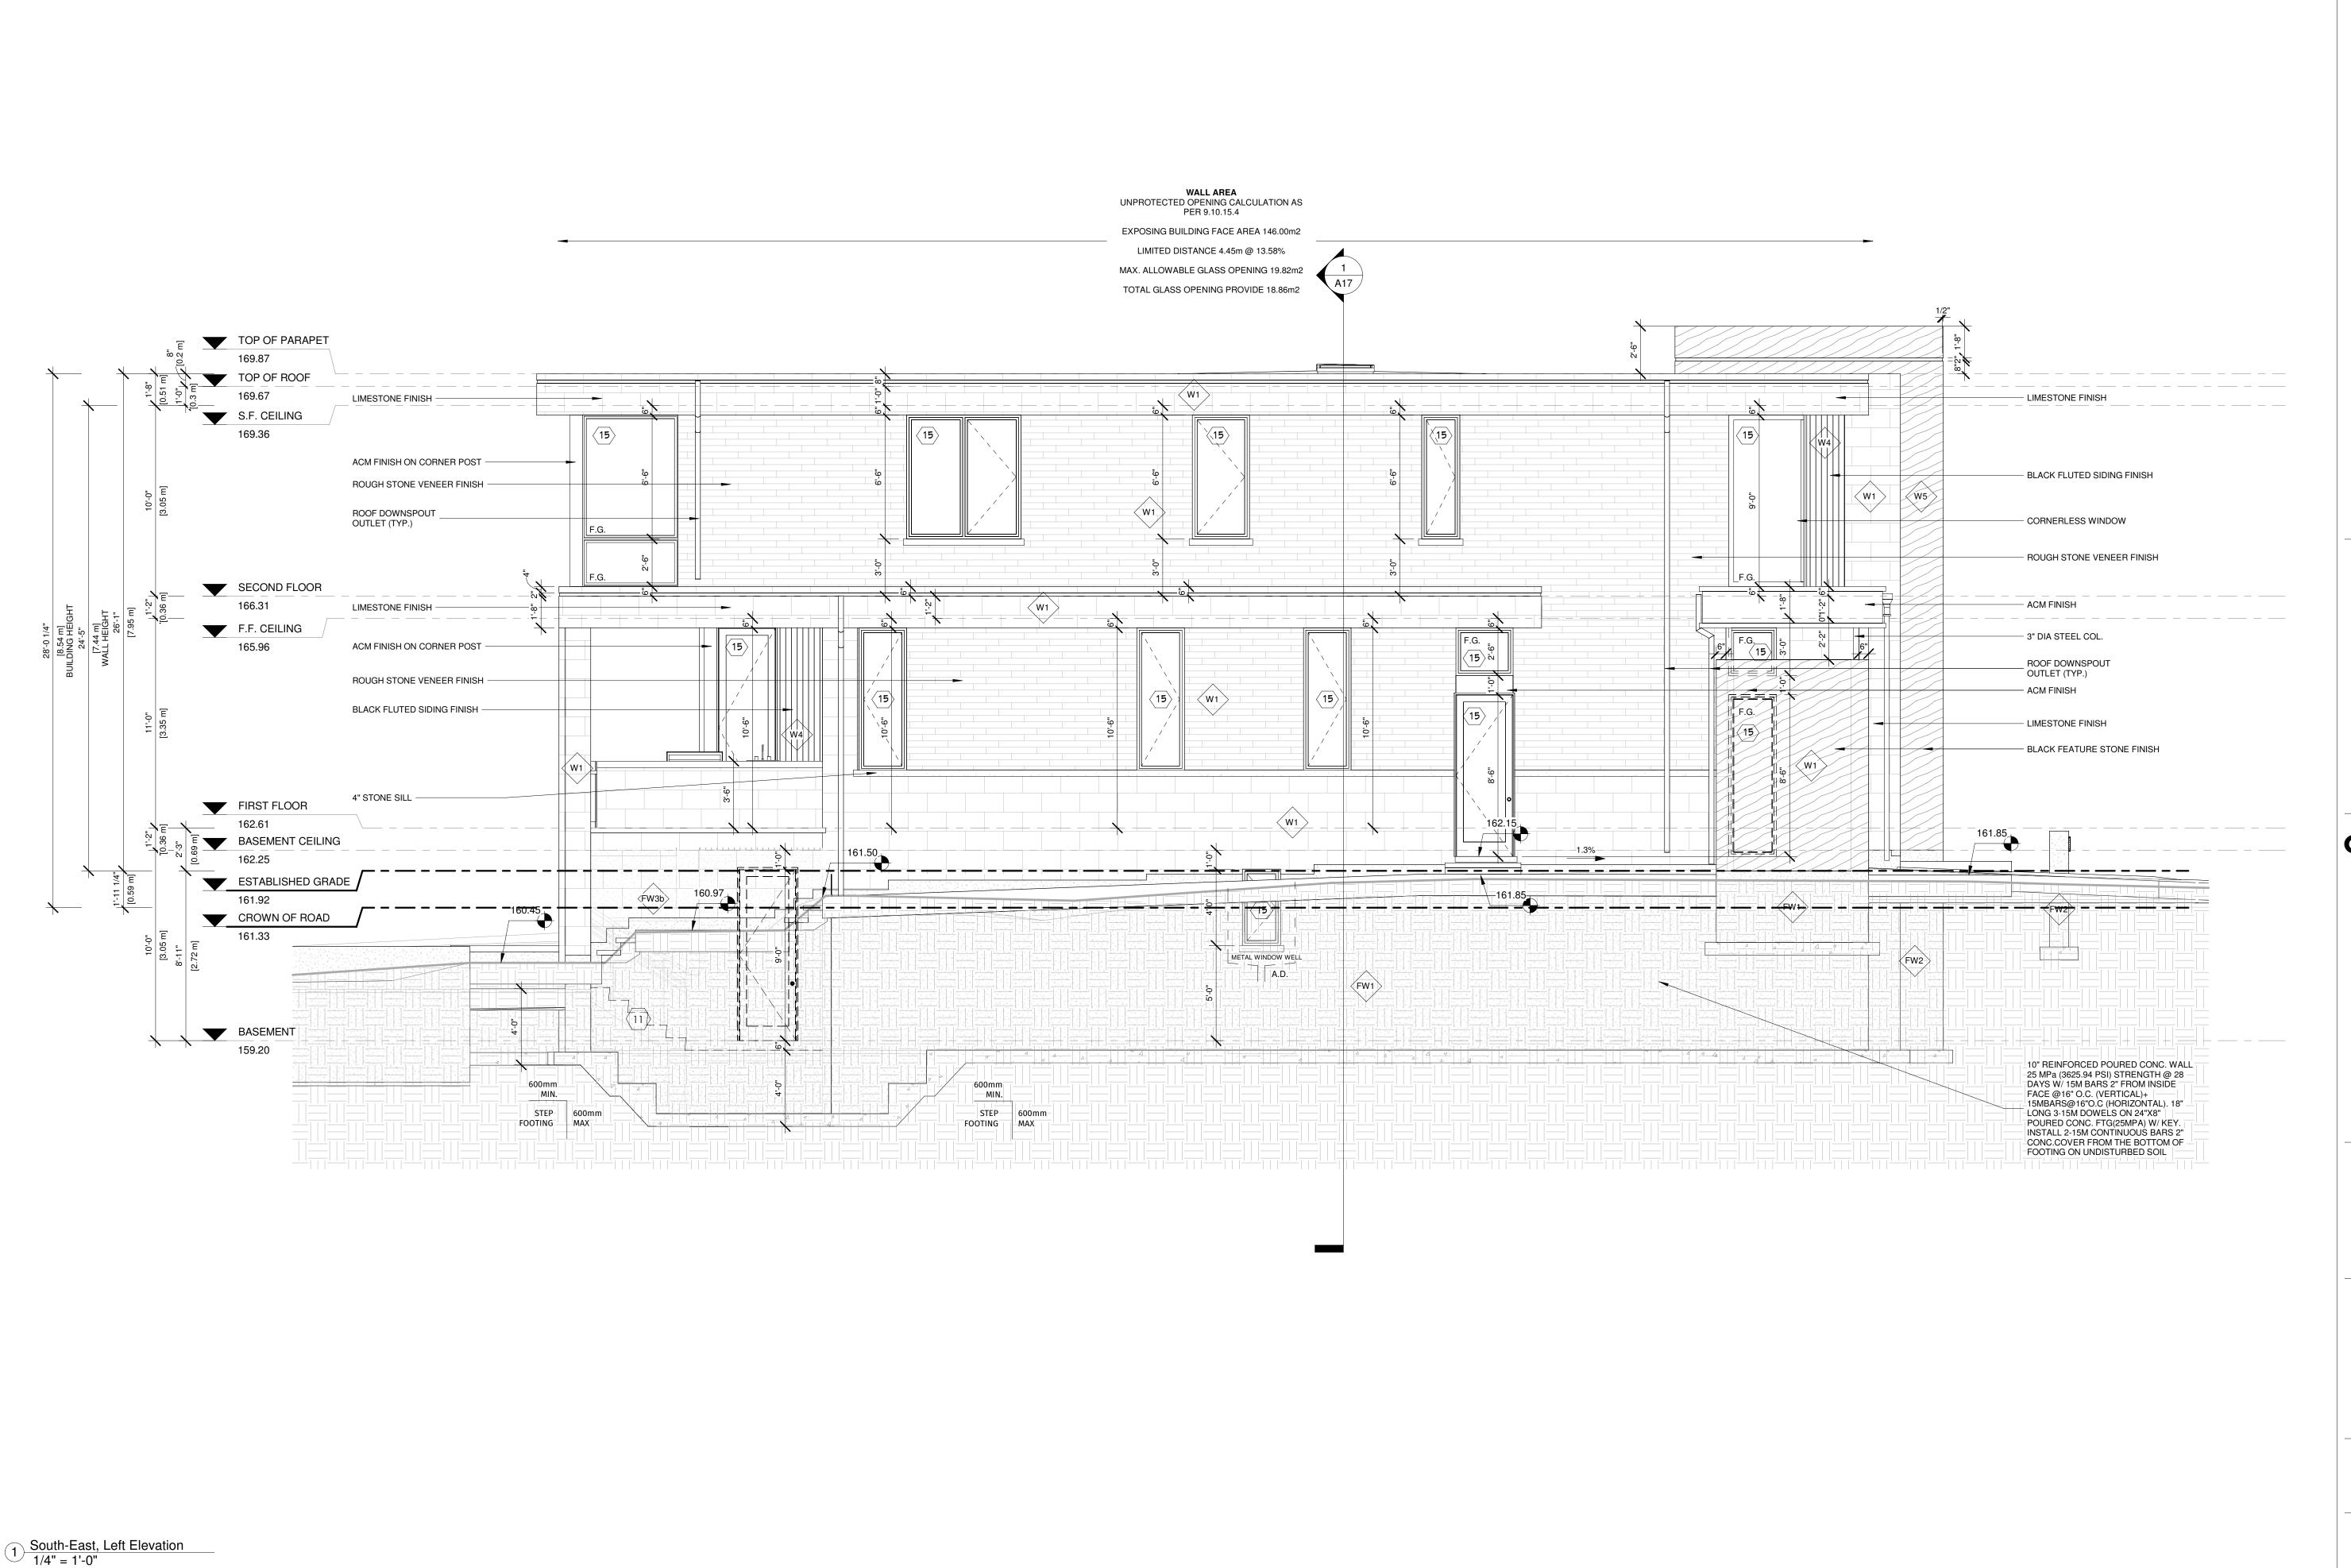
ΑT


**REAR ELEVATION** 

Project number:
Rev. no.::
Scale:
Date:
Drawn by:
Approved by:

2022-41 1/4" = 1'-0" 2023-06-14 4:55:50 PM C.C.

Drawing number:



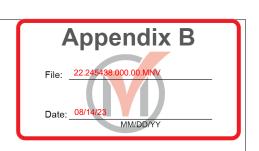

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REGISTRATION INFORMATION

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CONTEMPO STUDIO
FIRM NAME

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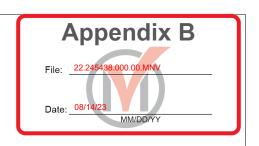
ΑT


LEFT ELEVATION

Project number:
Rev. no.::
Scale:
Date:
Drawn by:
Approved by:

2022-41 1/4" = 1'-0" 2023-06-14 4:55:51 PM C.C. M.Z.

Drawing number:



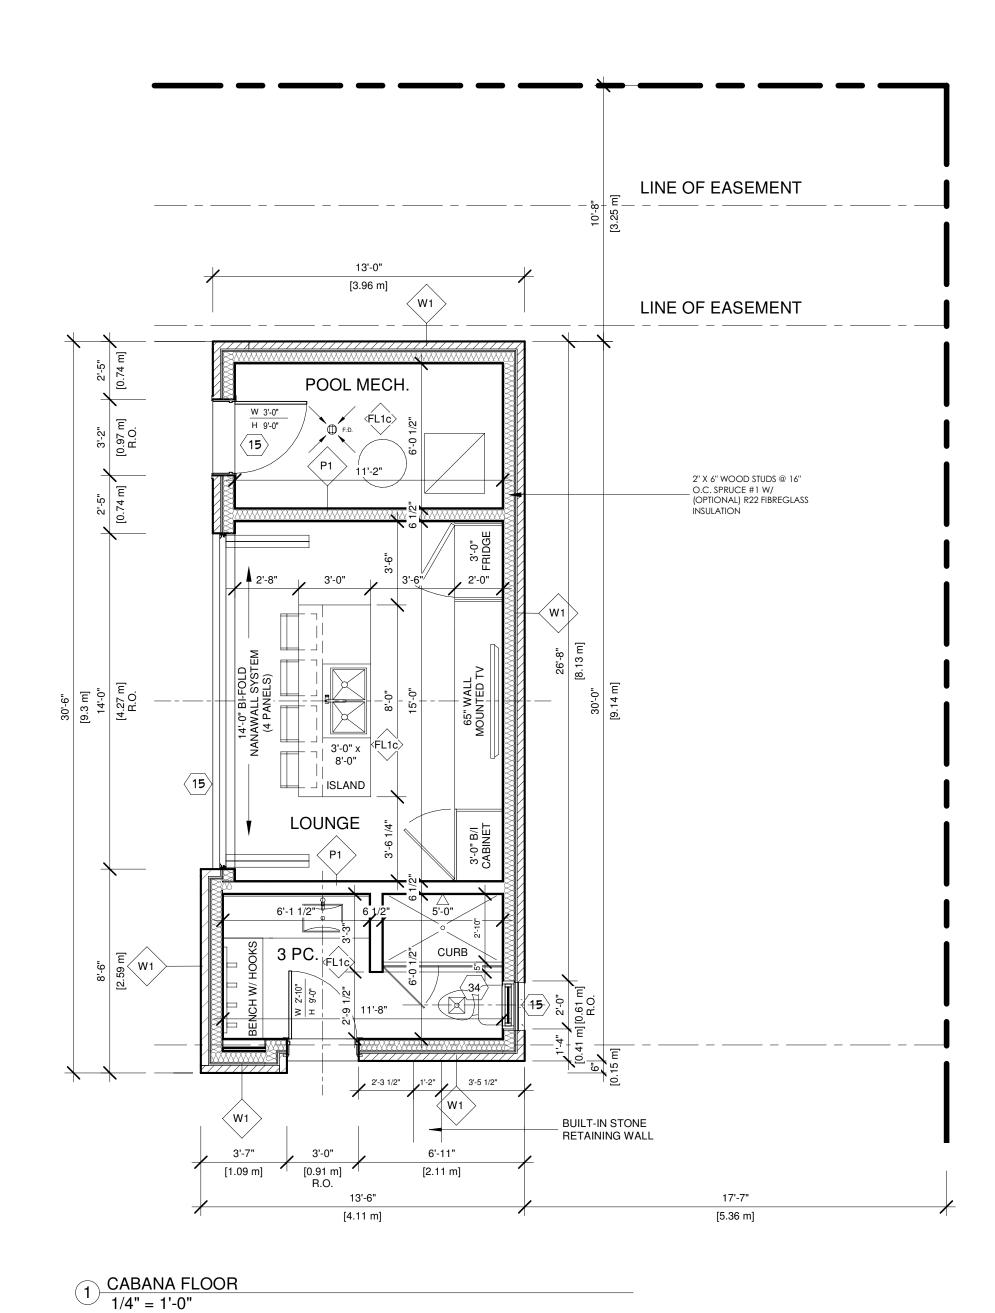

ROOF SCUPPER PARAPET WALL 16'-0" 14'-8" CABANA "FLAT" ROOF ಓ ಕ R3 2 PLY MODIFIED ROOFING BITUMEN MEMBRANE ROOFING ON 5/8" T&G EXT. TYPE PLYWOOD ON 2"x4" WOOD SLEEPER @ 16 O.C SPR. #1 STRIPS IN MANNER THAT WOULD FACILITATE POSITIVE ROOF DRAINAGE TOWARDS ROOF SCUPPER ON ROOF JOISTS SCUPPER BUILD UP ROOF 2% TO
- DIRECT WATER AWAY FROM PARAPET WALL [5.36 m] PARAPET WALL 11'-5"

> 2 CABANA ROOF 1/4" = 1'-0"

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FIRM NAME

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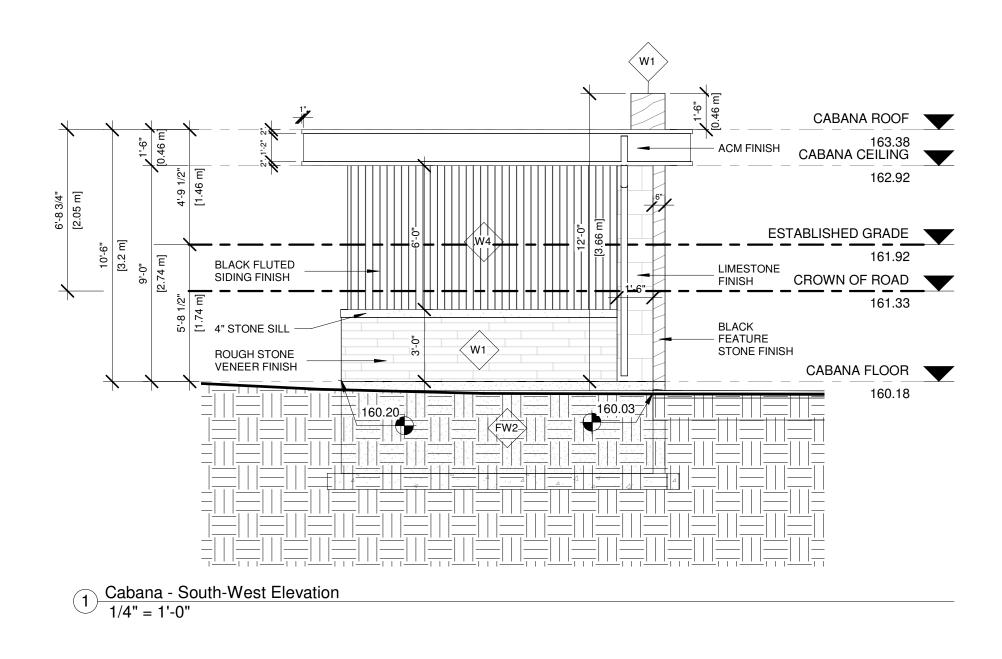
67 BABCOMBE DR THORNHILL, ON


CABANA PLANS

Project number: Rev. no.:: Scale: Date: Drawn by: 2022-41 1/4" = 1'-0" 2023-06-14 4:55:52 PM C.C. M.Z.


Drawing number:


Approved by:



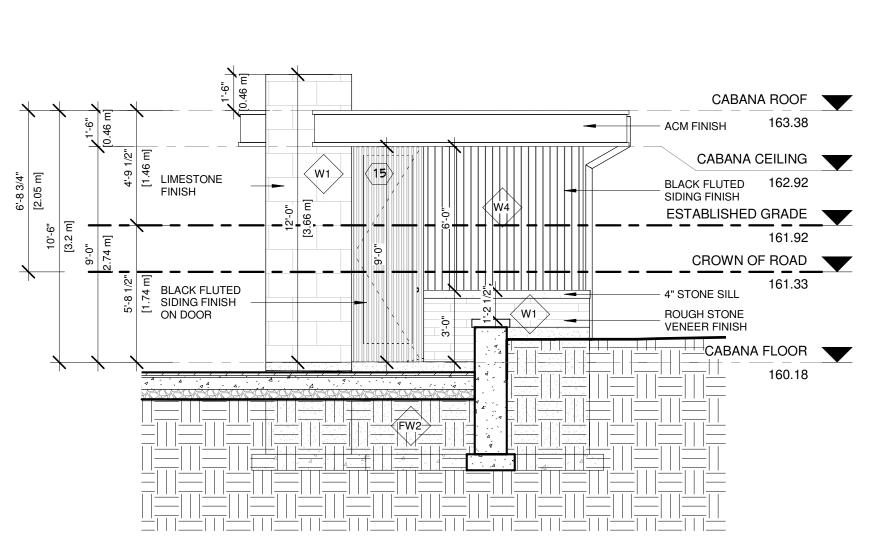

Cabana - North-East Elevation
1/4" = 1'-0"

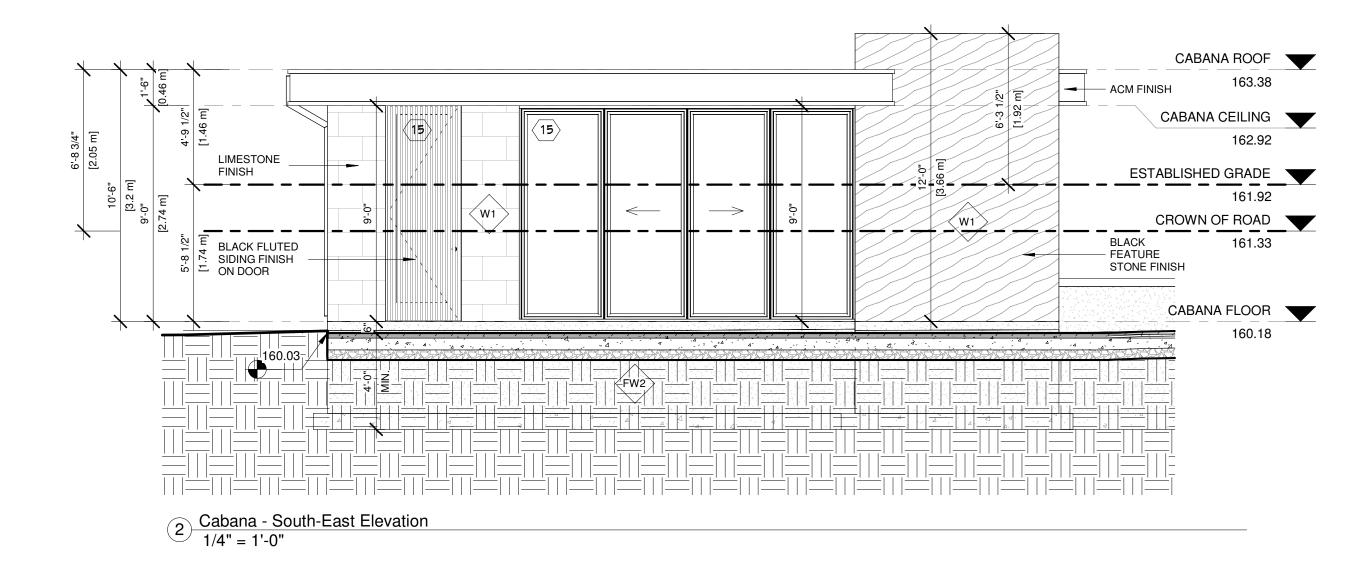

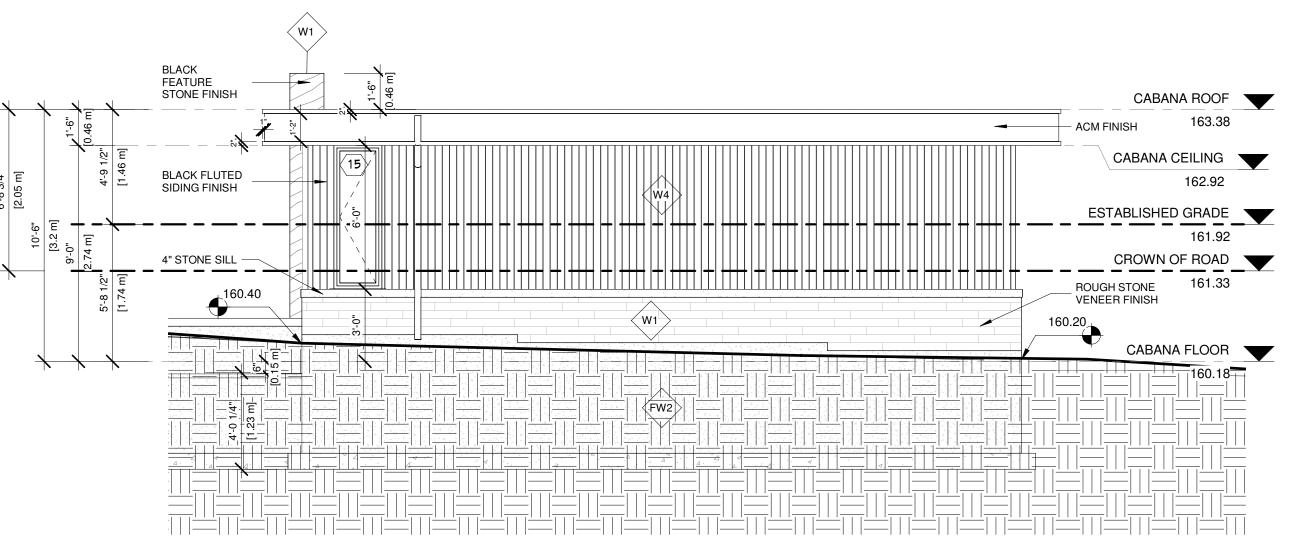

Cabana - North-West Elevation
1/4" = 1'-0"



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FIRM NAME

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2 STOREY DETACHED WELLING

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CABANA ELEVATIONS

Project number: Rev. no.:: Scale: Date: Drawn by: 2022-41 1/4" = 1'-0" 2023-06-14 4:55:53 PM C.C. M.Z.

Drawing number:

Approved by: